

YG-DCO-022(B)

Yorkshire Green Energy Enablement (GREEN) Project

Volume 2

Document 2.15(B) Design Drawings

Final Issue B
April 2023

Planning Inspectorate Reference: EN020024

Infrastructure Planning (Applications: Prescribed Forms and
Procedure) Regulations 2009 Regulation 5(2)(o)

nationalgrid


NATIONAL GRID (YORKSHIRE GREEN ENERGY ENABLEMENT PROJECT) ORDER
LIST OF DESIGN DRAWINGS
REGULATION 5(2)(o)
SHEET 1 OF 2

Legend

Notes

1. THIS DRAWING IS SCALED AT PAPER SIZE A1. THEREFORE ANY PRINTS TAKEN AT SMALLER SIZES WILL AFFECT ACCURACY OF THE MEASUREMENT UNITS AND SHOULD NOT BE SCALED AGAINST.
2. FOR ADDITIONAL DETAIL ON THE DRAWING SUITES, PLEASE REFER TO DOCUMENT 2.3 DRAWING GUIDANCE DOCUMENT, LOCATED IN VOLUME 2 OF THE DCO APPLICATION.

DOCUMENT NUMBER	DRAWING TITLE	SHEET NUMBER	REVISION
DCO_DE/KP/01_01	LIST OF DESIGN DRAWINGS	1 OF 2	B
DCO_DE/KP/01_02	LIST OF DESIGN DRAWINGS	2 OF 2	B
DCO_DE/PS/01_01	DESIGN DRAWING: EXPLANATORY OVERHEAD LINE PROFILE	1 OF 1	A
DCO_DE/PS/03_01	DESIGN DRAWING: INDICATIVE OVERHEAD LINE PROFILE YR & 2TW ROUTES	1 OF 1	A
DCO_DE/PS/04_01	DESIGN DRAWING: INDICATIVE OVERHEAD LINE PROFILE YR & YN ROUTES	1 OF 2	A
DCO_DE/PS/04_02	DESIGN DRAWING: INDICATIVE OVERHEAD LINE PROFILE YR & YN ROUTES	2 OF 2	A
DCO_DE/PS/05_01	DESIGN DRAWING: INDICATIVE OVERHEAD LINE PROFILE SP ROUTE	1 OF 2	A
DCO_DE/PS/05_02	DESIGN DRAWING: INDICATIVE OVERHEAD LINE PROFILE SP ROUTE	2 OF 2	A
DCO_DE/PS/06_01	DESIGN DRAWING: INDICATIVE OVERHEAD LINE PROFILE XC ROUTE	1 OF 14	A
DCO_DE/PS/06_02	DESIGN DRAWING: INDICATIVE OVERHEAD LINE PROFILE XC ROUTE	2 OF 14	A
DCO_DE/PS/06_03	DESIGN DRAWING: INDICATIVE OVERHEAD LINE PROFILE XC ROUTE	3 OF 14	A
DCO_DE/PS/06_04	DESIGN DRAWING: INDICATIVE OVERHEAD LINE PROFILE XC ROUTE	4 OF 14	A
DCO_DE/PS/06_05	DESIGN DRAWING: INDICATIVE OVERHEAD LINE PROFILE XC ROUTE	5 OF 14	A
DCO_DE/PS/06_06	DESIGN DRAWING: INDICATIVE OVERHEAD LINE PROFILE XC ROUTE	6 OF 14	A
DCO_DE/PS/06_07	DESIGN DRAWING: INDICATIVE OVERHEAD LINE PROFILE XC ROUTE	7 OF 14	A
DCO_DE/PS/06_08	DESIGN DRAWING: INDICATIVE OVERHEAD LINE PROFILE XC ROUTE	8 OF 14	A
DCO_DE/PS/06_09	DESIGN DRAWING: INDICATIVE OVERHEAD LINE PROFILE XC ROUTE	9 OF 14	A
DCO_DE/PS/06_10	DESIGN DRAWING: INDICATIVE OVERHEAD LINE PROFILE XC ROUTE	10 OF 14	A
DCO_DE/PS/06_11	DESIGN DRAWING: INDICATIVE OVERHEAD LINE PROFILE XC ROUTE	11 OF 14	A
DCO_DE/PS/06_12	DESIGN DRAWING: INDICATIVE OVERHEAD LINE PROFILE XC ROUTE	12 OF 14	A
DCO_DE/PS/06_13	DESIGN DRAWING: INDICATIVE OVERHEAD LINE PROFILE XC ROUTE	13 OF 14	A
DCO_DE/PS/06_14	DESIGN DRAWING: INDICATIVE OVERHEAD LINE PROFILE XC ROUTE	14 OF 14	A
DCO_DE/PS/07_01	DESIGN DRAWING: INDICATIVE OVERHEAD LINE PROFILE XC, XD & PHG ROUTES	1 OF 2	A
DCO_DE/PS/07_02	DESIGN DRAWING: INDICATIVE OVERHEAD LINE PROFILE XC, XD & PHG ROUTES	2 OF 2	A
DCO_DE/PS/08_01	DESIGN DRAWING: INDICATIVE OVERHEAD LINE PROFILE 4YS & 4ZZ ROUTES	1 OF 1	A
DCO_DE/PS/09_01	DESIGN DRAWING: INDICATIVE OVERHEAD LINE PROFILE XC & XCP TEMPORARY ROUTES	1 OF 1	A
DCO_DE/PS/10_01	DESIGN DRAWING: INDICATIVE OVERHEAD LINE PROFILE XC TEMPORARY ROUTE	1 OF 2	A
DCO_DE/PS/10_02	DESIGN DRAWING: INDICATIVE OVERHEAD LINE PROFILE XC TEMPORARY ROUTE	2 OF 2	A
DCO_DE/PS/11_01	DESIGN DRAWING: INDICATIVE OVERHEAD LINE PROFILE XC & XD TEMPORARY ROUTES	1 OF 1	A
DCO_DE/PS/12_01	DESIGN DRAWING: INDICATIVE OVERHEAD LINE PROFILE YR & 2TW TEMPORARY ROUTES	1 OF 1	A
DCO_DE/PS/13_01	DESIGN DRAWING: INDICATIVE MINIMUM AND MAXIMUM LATTICE PYLON HEIGHTS	1 OF 1	A


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A	01/11/2022	FOR DCO SUBMISSION	AD	SF	EMD				
Issue	Date	Remarks	Drawn	Checked	Approved				
<p><u>Title</u></p> <p>NATIONAL GRID (YORKSHIRE GREEN ENERGY ENABLEMENT PROJECT) ORDER LIST OF DESIGN DRAWINGS REGULATION 5(2)(o) SHEET 1 OF 2</p>									
									
<p><u>Application Number</u></p> <p>EN020024</p>									
<p>National Grid Drawing Reference</p> <p>DCO_DE/KP/1_01</p>									
Scale	Sheet Size	Sheet	Issue						
N.T.S	A1	SHEET 1 OF 2		B					

NATIONAL GRID (YORKSHIRE GREEN ENERGY ENABLEMENT PROJECT) ORDER LIST OF DESIGN DRAWINGS REGULATION 5(2)(o) SHEET 2 OF 2												Legend					
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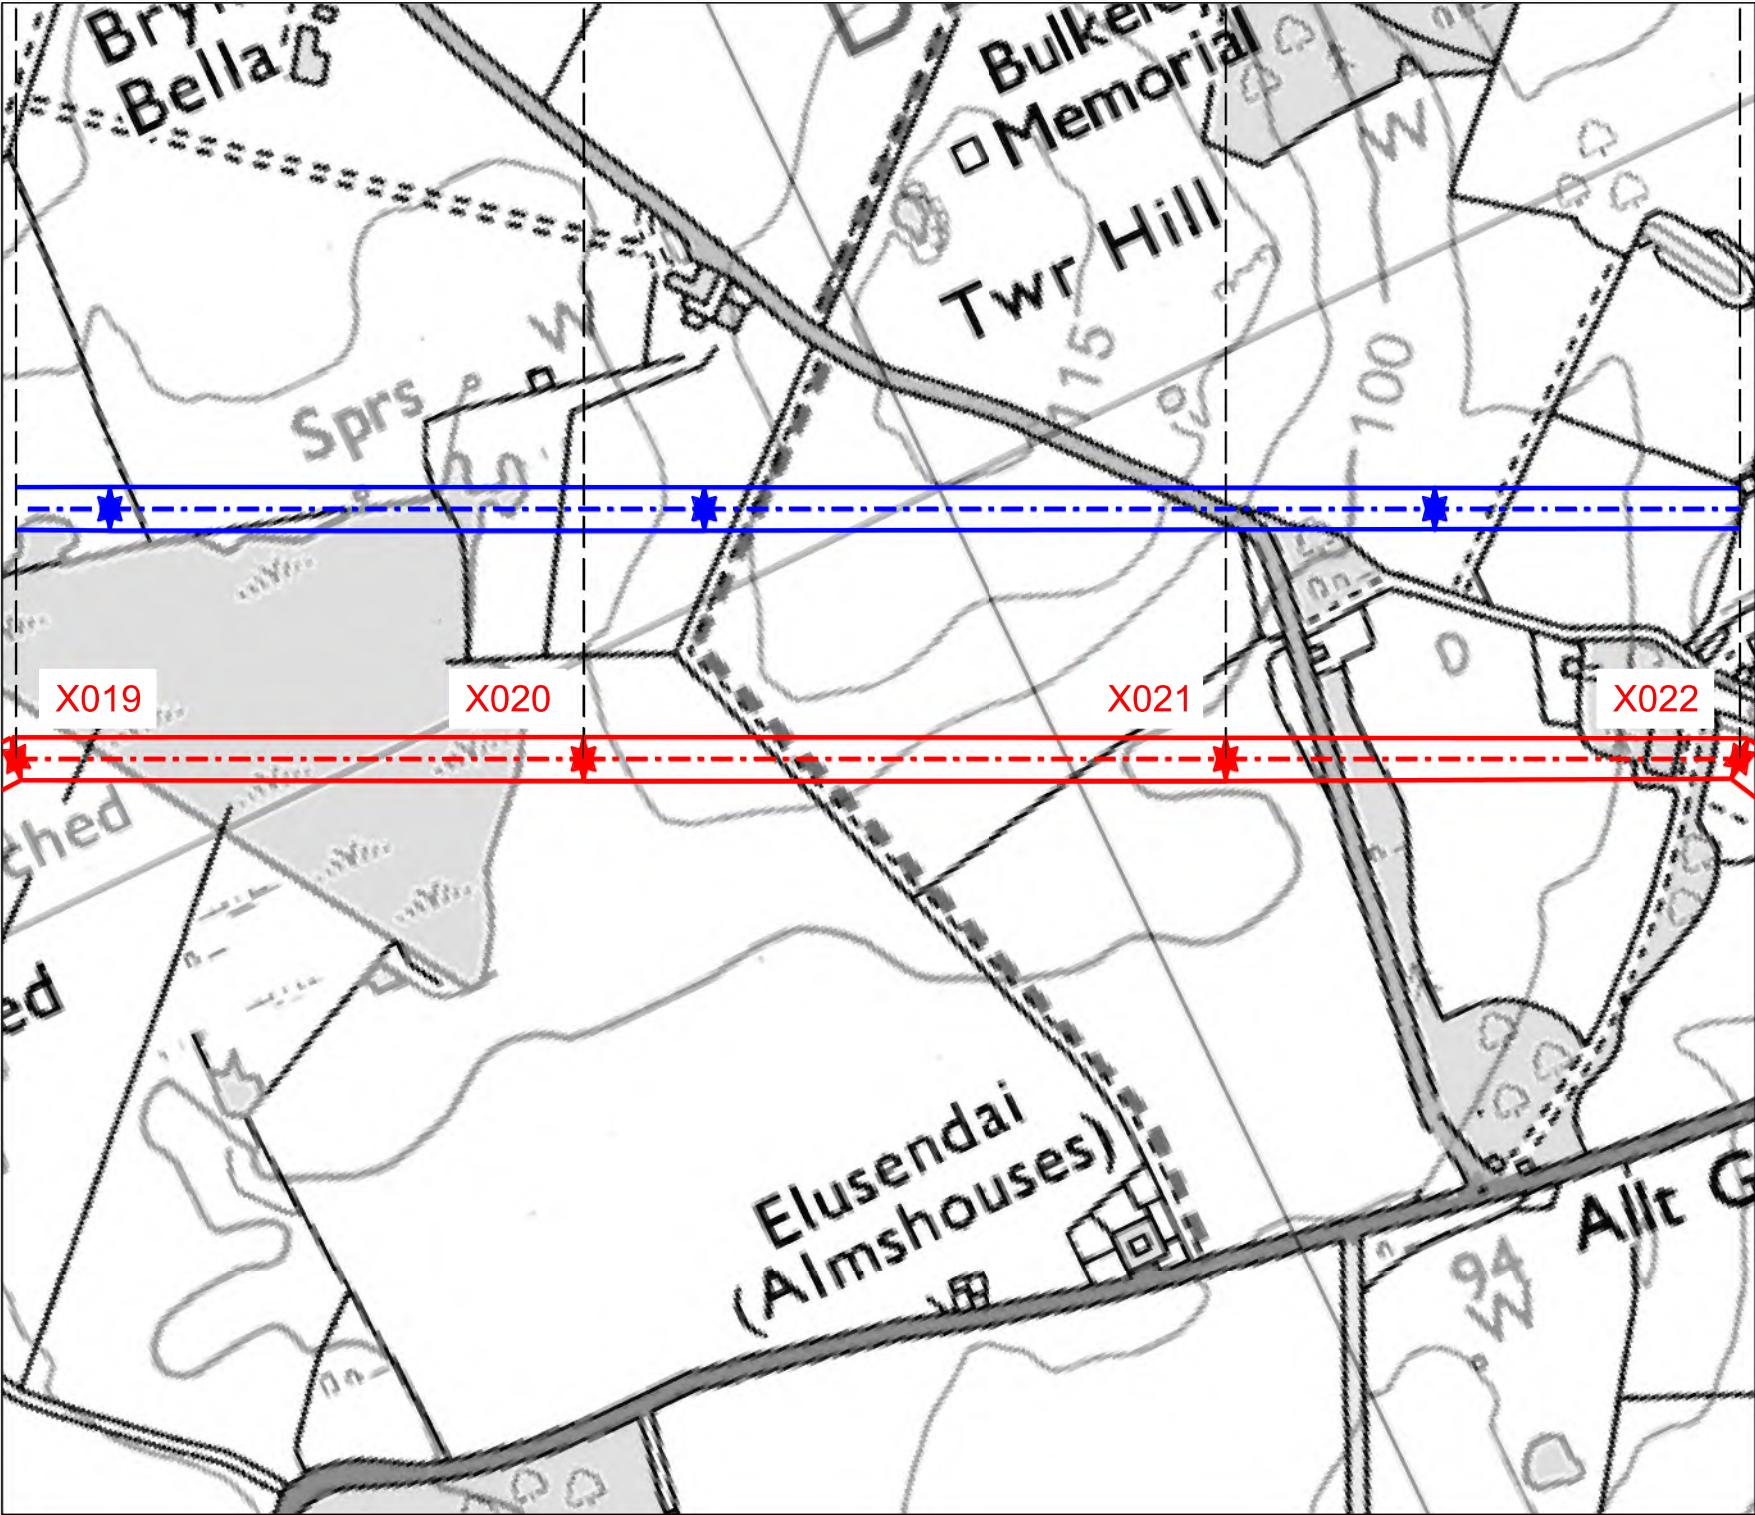
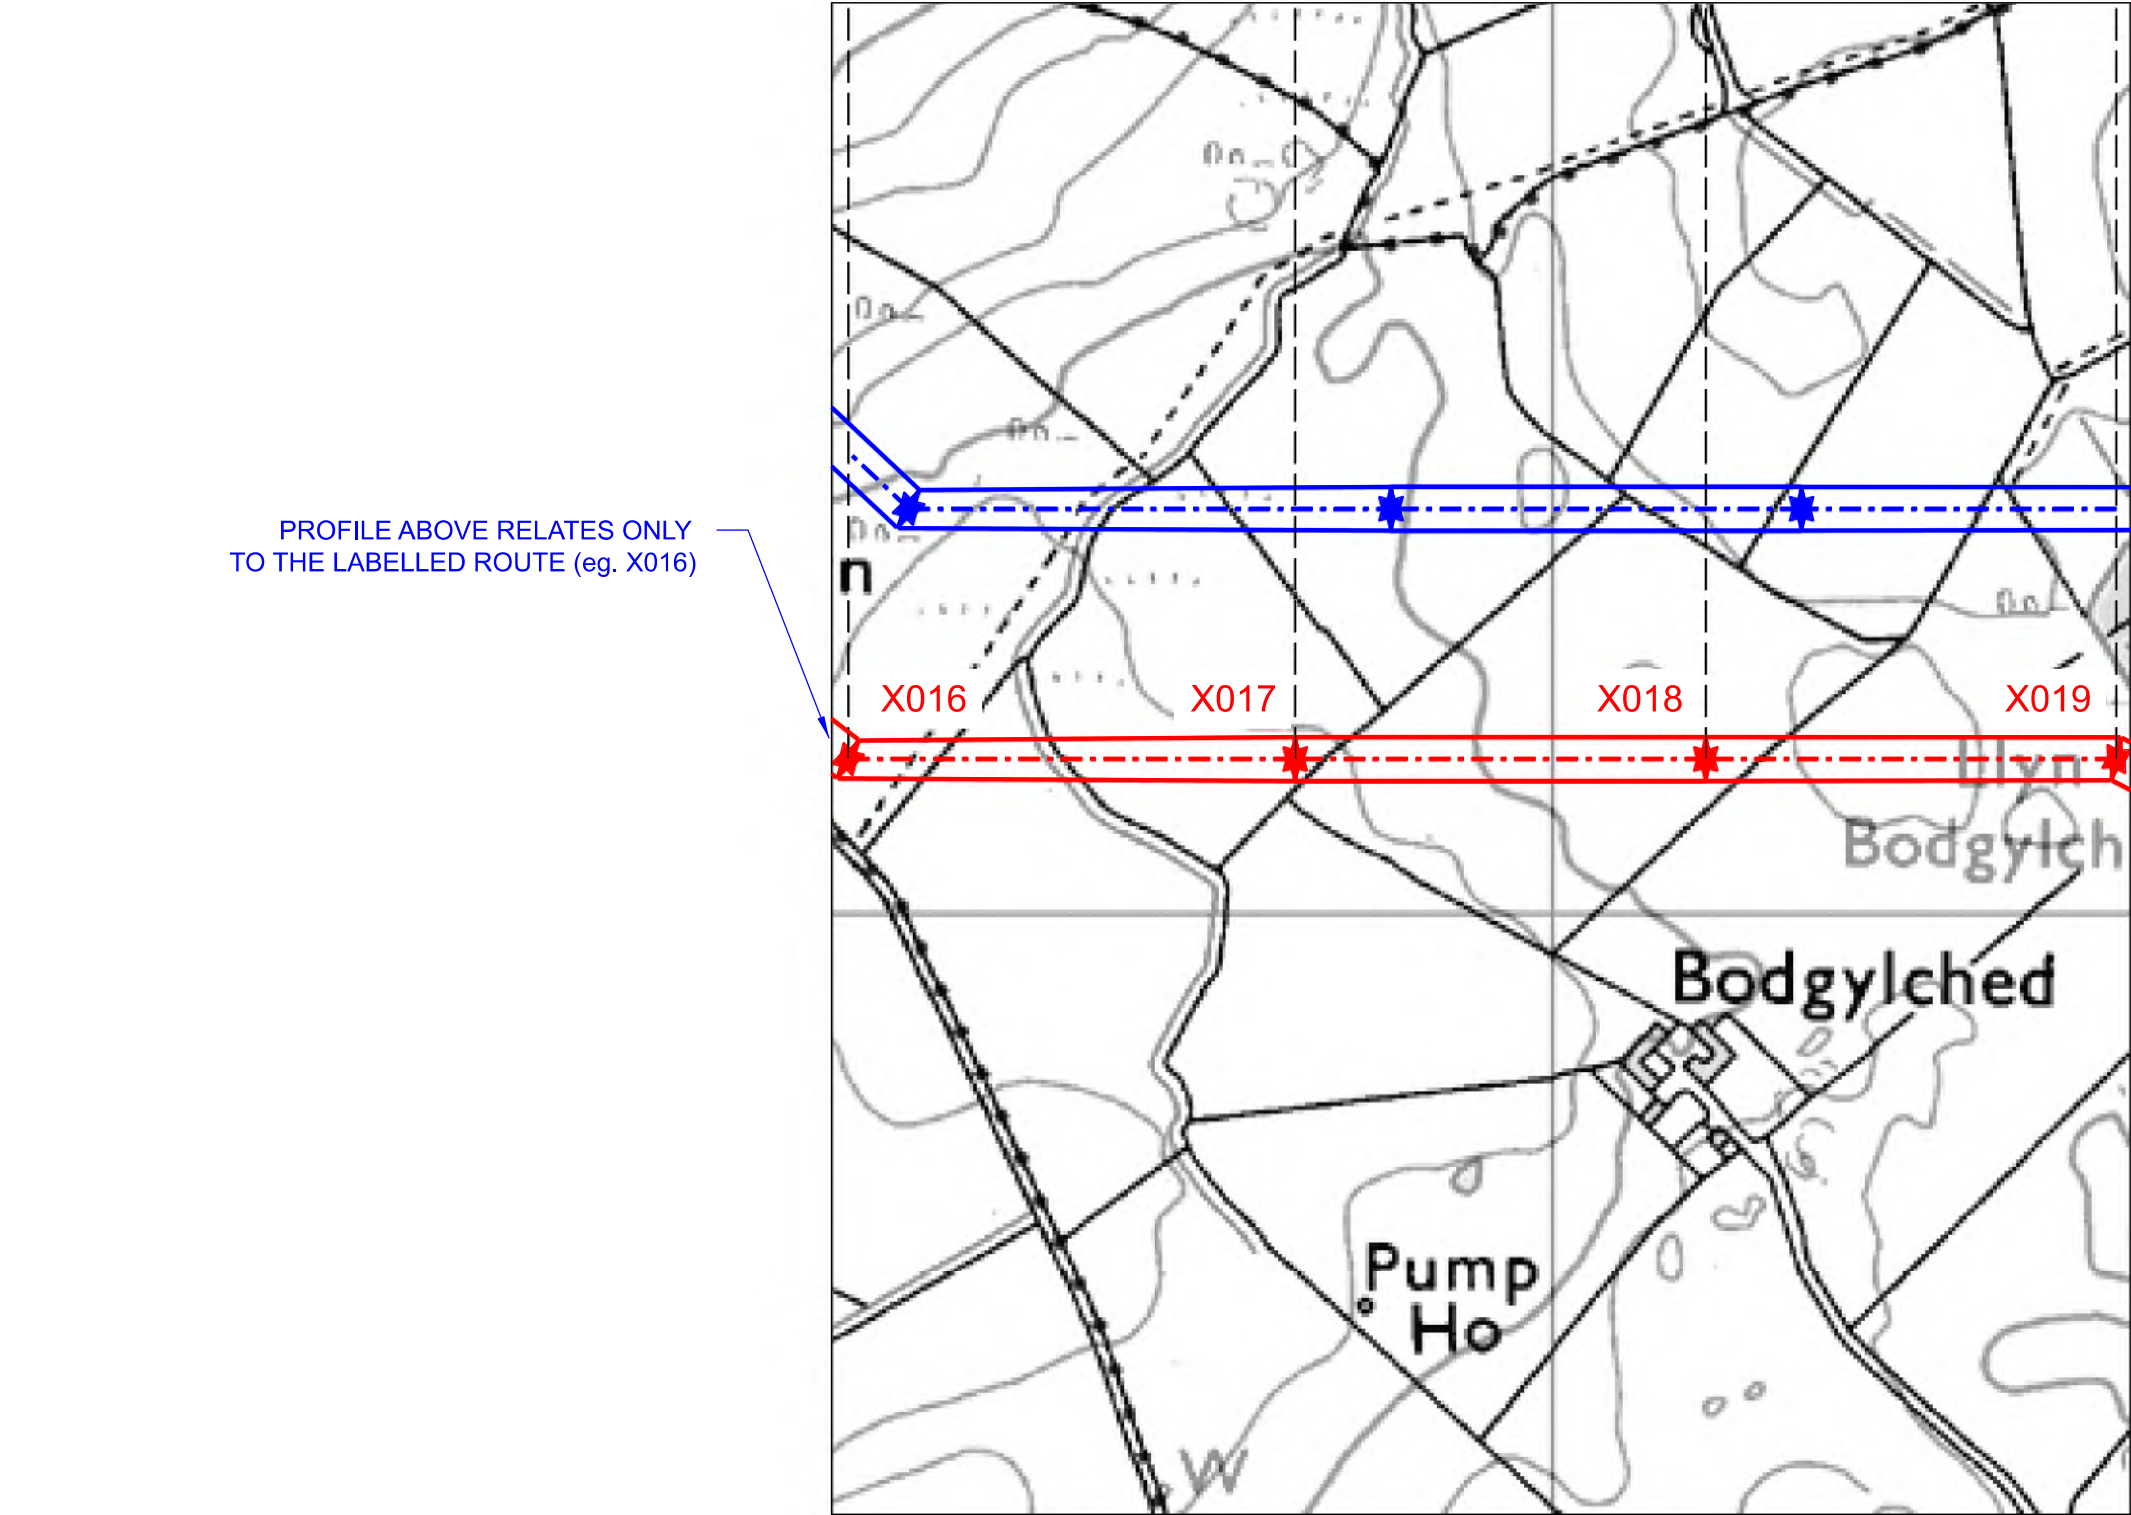
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EXPLANATORY SHEET

(DOES NOT REPRESENT ANY ASPECT OF THIS PROJECT)



- Notes
- THIS DRAWING IS SCALED AT PAPER SIZE A1, THEREFORE ANY PRINTS TAKEN AT SMALLER SIZES WILL AFFECT ACCURACY OF THE MEASUREMENT UNITS AND SHOULD NOT BE SCALED AGAINST.
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 - PROPOSED PROFILES BASED ON STATUTORY SAFETY CLEARANCES.
 - TREES AND VEGETATION ARE NOT SHOWN FOR CLARITY.
 - FOR ADDITIONAL DETAIL ON THE PLAN SUITES, PLEASE REFER TO DOCUMENT 2.3 PLAN GUIDANCE DOCUMENT, LOCATED IN VOLUME 2 OF THE DCO APPLICATION.

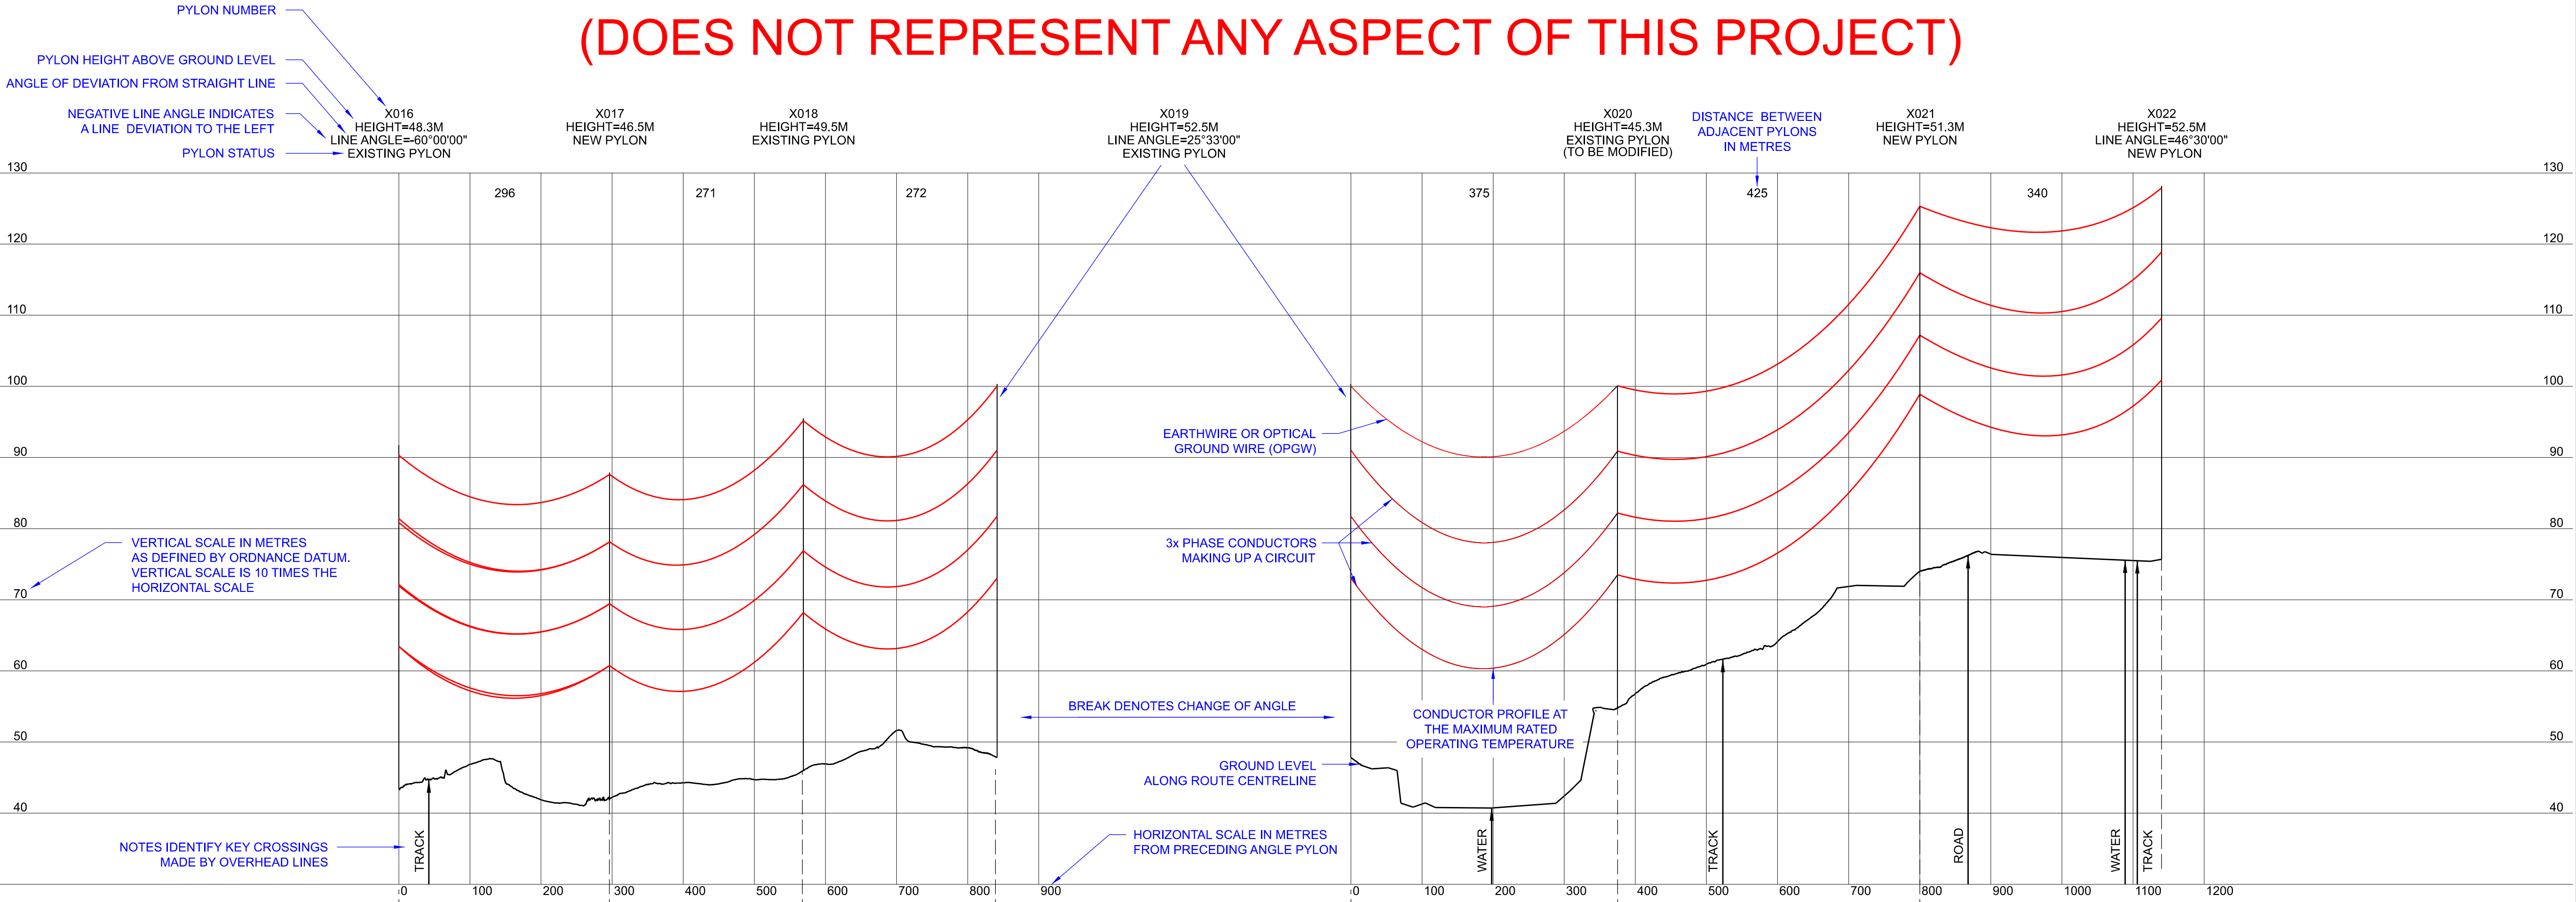

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Issue	Date	Remarks	Drawn	Checked	Approved


Title
NATIONAL GRID
(YORKSHIRE GREEN ENERGY
ENABLEMENT PROJECT) ORDER
DESIGN DRAWING:
EXPLANATORY OVERHEAD LINE PROFILE
REGULATION 5(2)(o)
SHEET 1 OF 1

nationalgrid

Application Number EN020024					
National Grid Drawing Reference DCO_DE/PS/01_01					
Scale H = 1:5000 V = 1:500	Sheet Size A1	Sheet SHEET 1 OF 1	Issue A		

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Legend

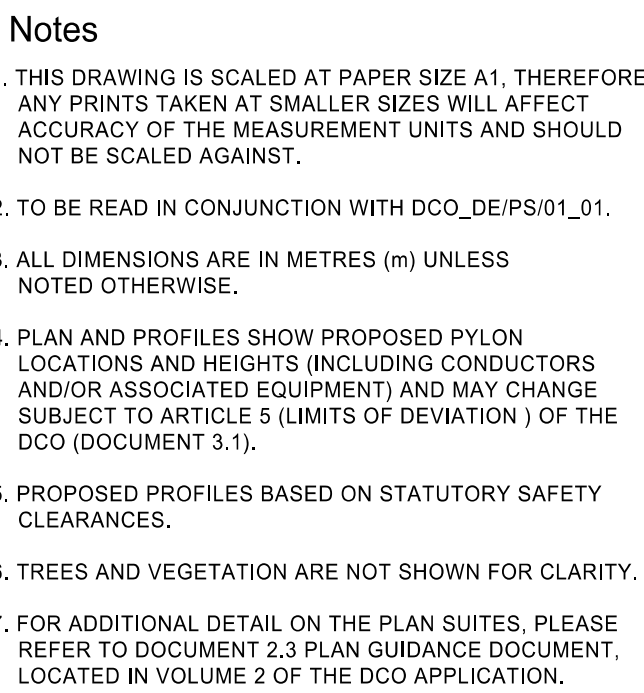

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Issue	Date	Remarks	Drawn	Checked	Approved

INDICATIVE OVERHEAD LINE PROFILE
YR & 2TW ROUTES
REGULATION 5(2)(o)
SHEET 1 OF 1

nationalgrid

Application Number

EN020024



Optional Grid Drawing Reference

DCO_DE/PS/03_01

Scale	Sheet Size	Sheet	Issue
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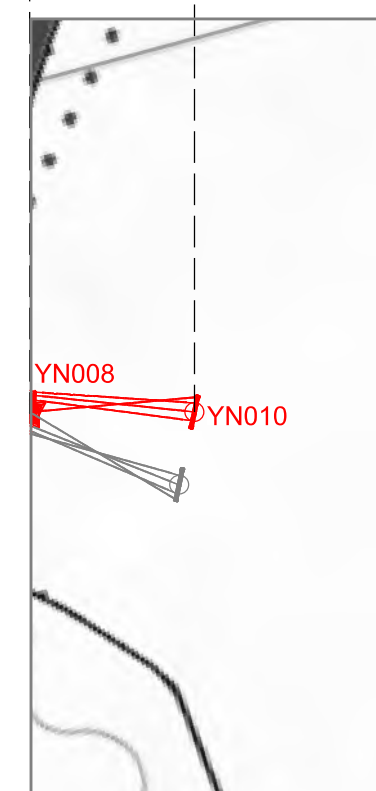
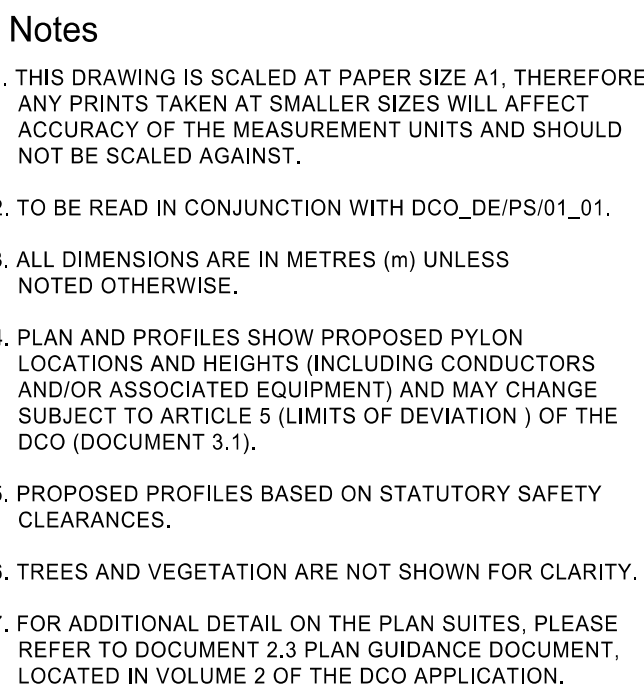


A	01/11/2022	FOR DCO SUBMISSION	FE	SF	EMD
Issue	Date	Remarks	Drawn	Checked	Approved

nationalgrid

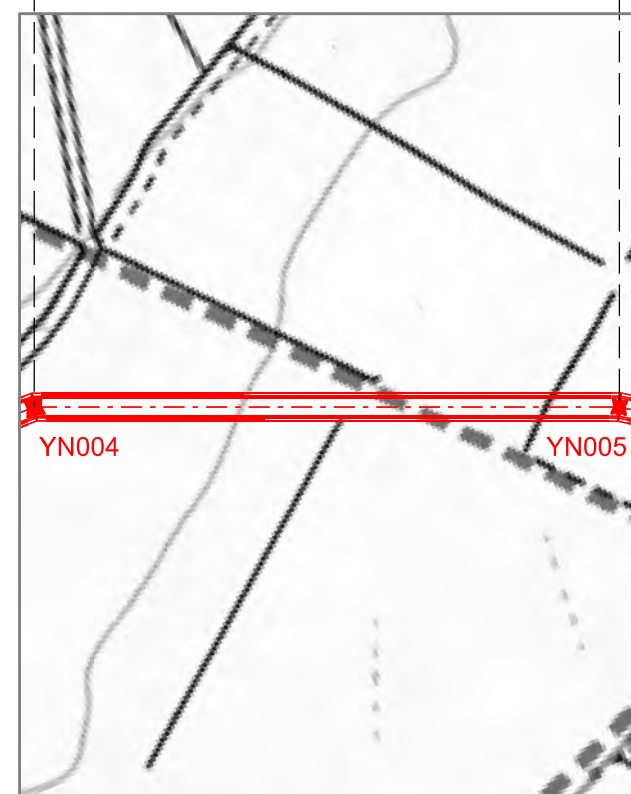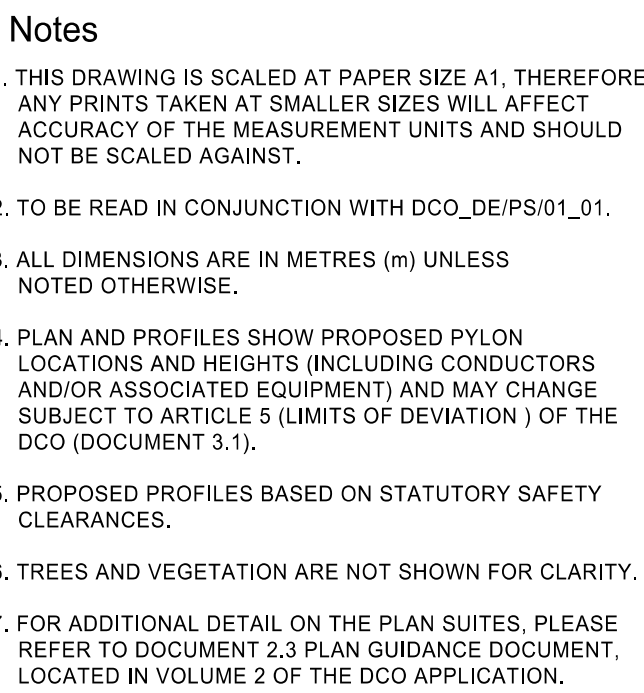DCO_DE/PS/04_01

Legend



title

NATIONAL GRID
(YORKSHIRE GREEN ENERGY
ENABLEMENT PROJECT) ORDER
DESIGN DRAWING:
INDICATIVE OVERHEAD LINE PROFILE
YR & YN ROUTES
REGULATION 5(2)(o)
SHEET 2 OF 2

Application Number


EN020024

International Grid Drawing Reference

Scale Hx = 1:5000 Vert = 1:500	<u>Sheet Size</u> A1	<u>Sheet</u> SHEET 2 OF 2	<u>Issue</u> A
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Legend



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A	01/11/2022	FOR DCO SUBMISSION	FE	SF	EM
Issue	Date	Remarks	Drawn	Checked	Approved
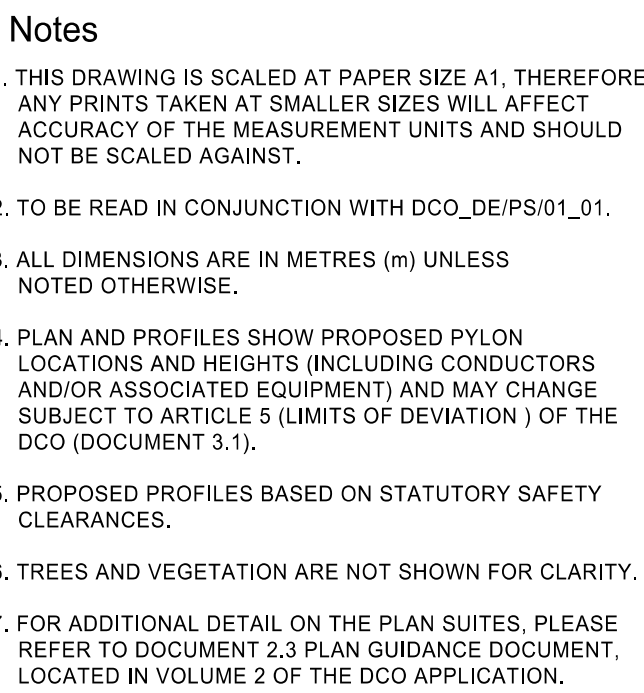
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**NATIONAL GRID
(YORKSHIRE GREEN ENERGY
ENABLEMENT PROJECT) ORDER
DESIGN DRAWING:
INDICATIVE OVERHEAD LINE PROFILE
SP ROUTE
REGULATION 5(2)(o)
SHEET 1 OF 2**

nationalgrid

Application Number

EN020024

ational Grid Drawing Reference

DCO_DE/PS/05_01

Hz	Sheet Size	Sheet	Issue
Hz = 1:5000	A1	SHEET 1 OF 2	A

NATIONAL GRID (YORKSHIRE GREEN ENERGY ENABLEMENT PROJECT) ORDER
DESIGN DRAWING: INDICATIVE OVERHEAD LINE PROFILE SP ROUTE
REGULATION 5(2)(o)
SHEET 2 OF 2

Legend

Notes

1. THIS DRAWING IS SCALED AT PAPER SIZE A1, THEREFORE ANY PRINTS TAKEN AT SMALLER SIZES WILL AFFECT ACCURACY OF THE MEASUREMENT UNITS AND SHOULD NOT BE SCALED AGAINST.
2. TO BE READ IN CONJUNCTION WITH DCO_DE/PS/01_01.
3. ALL DIMENSIONS ARE IN METRES (m) UNLESS NOTED OTHERWISE.
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Issue	Date	Remarks	Drawn	Checked	Approved
A	01/11/2022	FOR DCO SUBMISSION	FE	SF	EMD

Title
NATIONAL GRID
(YORKSHIRE GREEN ENERGY
ENABLEMENT PROJECT) ORDER
DESIGN DRAWING:
INDICATIVE OVERHEAD LINE PROFILE
SP ROUTE
REGULATION 5(2)(o)
SHEET 2 OF 2

nationalgrid


Application Number
EN020024

National Grid Drawing Reference
DCO_DE/PS/05_02

Scale H _z = 1:5000 Vert = 1:500	Sheet Size A1	Sheet SHEET 2 OF 2	Issue A
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Legend





A	01/11/2022	FOR DCO SUBMISSION	FE	SF	EM
Issue	Date	Remarks	Drawn	Checked	Approved

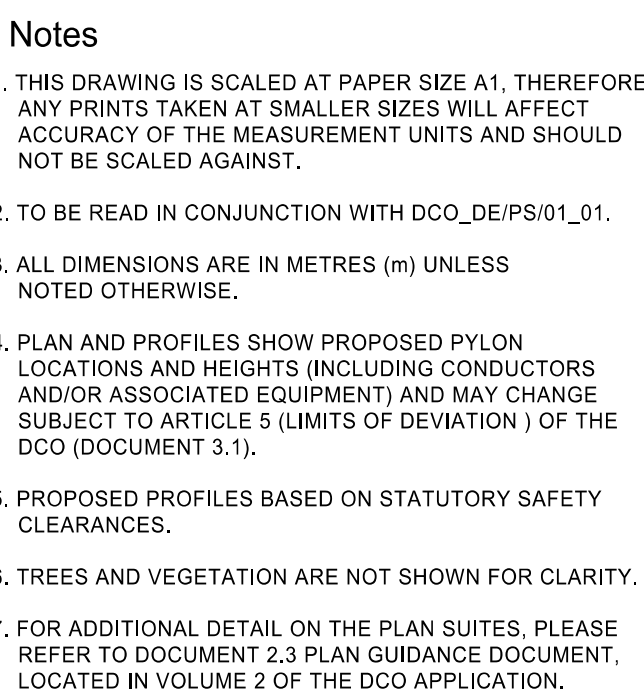nationalgrid

DCO DE/PS/06_01

Scale	Sheet Size	Sheet	Issue
Hz = 1:5000			

Legend

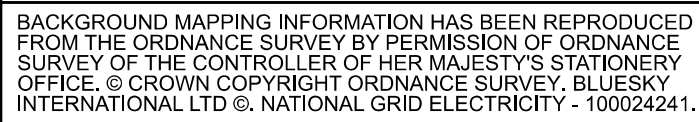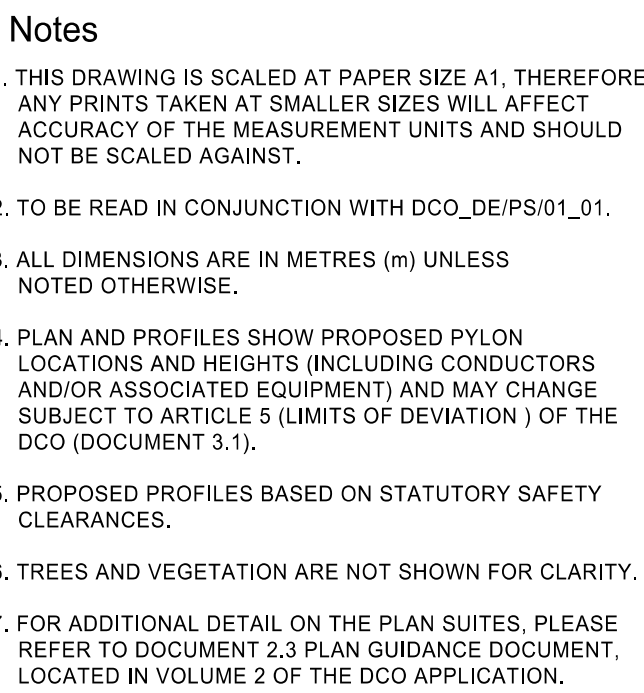

A	01/11/2022	FOR DCO SUBMISSION	FE	SF	EMD
Issue	Date	Remarks	Drawn	Checked	Approved

Title

NATIONAL GRID
(YORKSHIRE GREEN ENERGY
ENABLEMENT PROJECT) ORDER
DESIGN DRAWING:
INDICATIVE OVERHEAD LINE PROFILE
XC ROUTE
REGULATION 5(2)(o)
SHEET 2 OF 14

nationalgrid

Application Number

EN020024


National Grid Drawing Reference

DCO_DE/PS/06_02

Scale	Sheet Size	Sheet	Issue
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A	01/11/2022	FOR DCO SUBMISSION	FE	SF	EMD
Issue	Date	Remarks	Drawn	Checked	Approved

title

NATIONAL GRID
(YORKSHIRE GREEN ENERGY
ENABLEMENT PROJECT) ORDER
DESIGN DRAWING:
INDICATIVE OVERHEAD LINE PROFILE
XC ROUTE
REGULATION 5(2)(o)
SHEET 3 OF 14

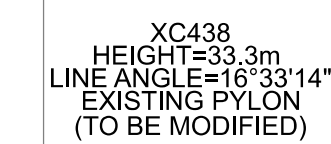nationalgrid

Application Number

EN020024



ational Grid Drawing Reference

DCO_DE/PS/06_03

Scale 1 in. = 1:5000	Sheet Size	Sheet	Issue
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H2 = 1:5000 Vert = 1:500	A1	SHEET 3 OF 14	A
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Legend



**NATIONAL GRID
(YORKSHIRE GREEN ENERGY
ENABLEMENT PROJECT) ORDER
DESIGN DRAWING:
INDICATIVE OVERHEAD LINE PROFILE
XC ROUTE
REGULATION 5(2)(o)
SHEET 4 OF 14**

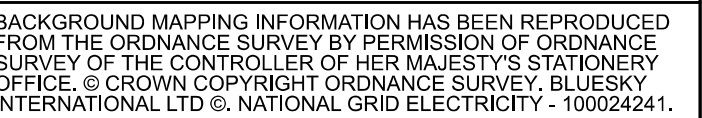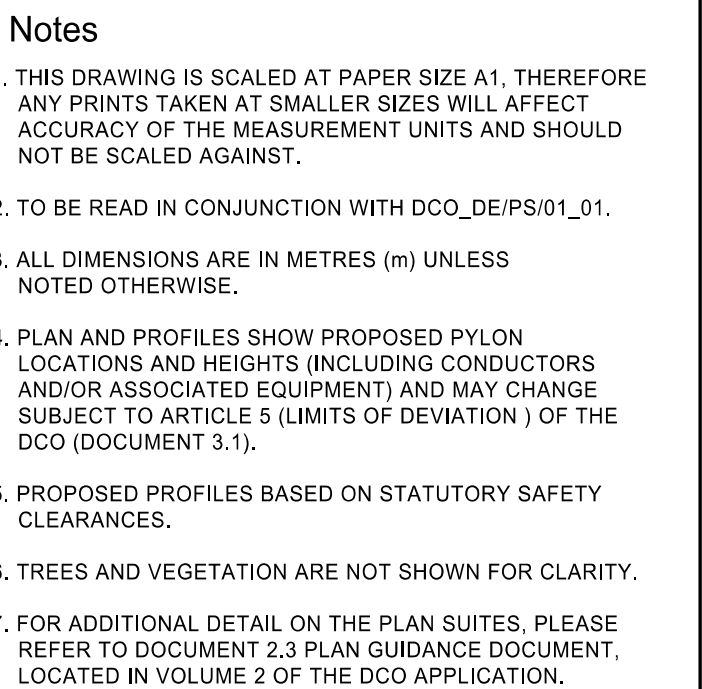
Application Number

EN020024

ational Grid Drawing Reference

DCO_DE/PS/06_04			
Scale Hz = 1:5000 Vert = 1:500	<u>Sheet Size</u> A1	<u>Sheet</u> SHEET 4 OF 14	<u>Issue</u> A

Legend

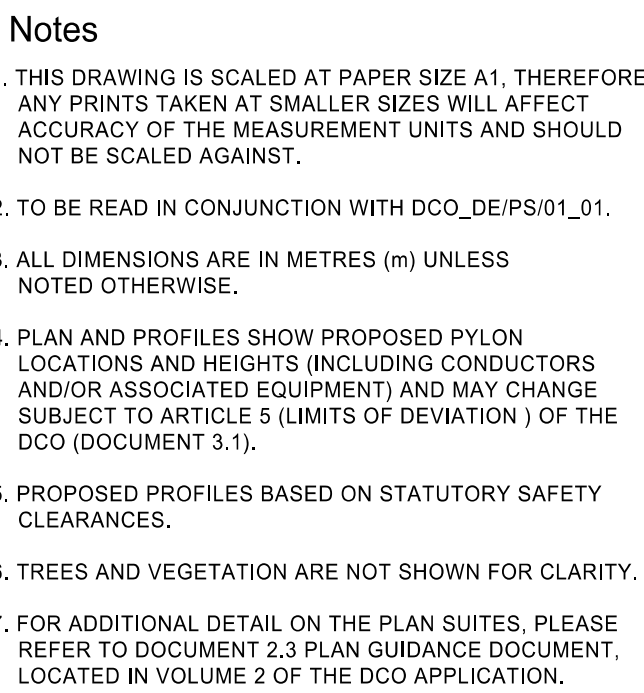

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A	01/11/2022	FOR DCO SUBMISSION	FE	SF	EMD
Issue	Date	Remarks	Drawn	Checked	Approved

**NATIONAL GRID
(YORKSHIRE GREEN ENERGY
ENABLEMENT PROJECT) ORDER
DESIGN DRAWING:
INDICATIVE OVERHEAD LINE PROFILE
XC ROUTE
REGULATION 5(2)(o)
SHEET 5 OF 14**

nationalgrid

Application Number

EN020024

ational Grid Drawing Reference

<u>Scale</u> H _z = 1:5000 V _{er} t = 1:500	<u>Sheet Size</u> A1	<u>Sheet</u> SHEET 5 OF 14	<u>Issue</u> A
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NATIONAL GRID (YORKSHIRE GREEN ENERGY ENABLEMENT PROJECT) ORDER
DESIGN DRAWING: INDICATIVE OVERHEAD LINE PROFILE XC ROUTE
REGULATION 5(2)(o)
SHEET 6 OF 14

Legend

- Notes
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A	01/11/2022	FOR DCO SUBMISSION	FE	SF	EMD
Issue	Date	Remarks	Drawn	Checked	Approved

Title

NATIONAL GRID
(YORKSHIRE GREEN ENERGY
ENABLEMENT PROJECT) ORDER
DESIGN DRAWING:
INDICATIVE OVERHEAD LINE PROFILE
XC ROUTE
REGULATION 5(2)(o)
SHEET 6 OF 14


nationalgrid

<u>Application Number</u>		EN020024	
<u>National Grid Drawing Reference</u>			
DCO_DE/PS/06_06			
<u>Scale</u>	<u>Sheet Size</u>	<u>Sheet</u>	<u>Issue</u>
H _z = 1:5000 Vert = 1:500	A1	SHEET 6 OF 14	A

NATIONAL GRID (YORKSHIRE GREEN ENERGY ENABLEMENT PROJECT) ORDER
DESIGN DRAWING: INDICATIVE OVERHEAD LINE PROFILE XC ROUTE
REGULATION 5(2)(o)
SHEET 7 OF 14

Legend

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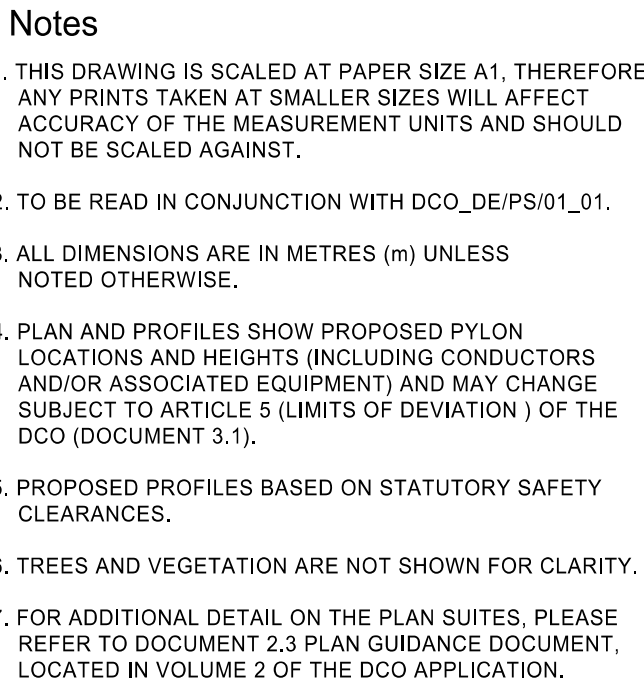
A	01/11/2022	FOR DCO SUBMISSION	FE	SF	EMD
Issue	Date	Remarks	Drawn	Checked	Approved

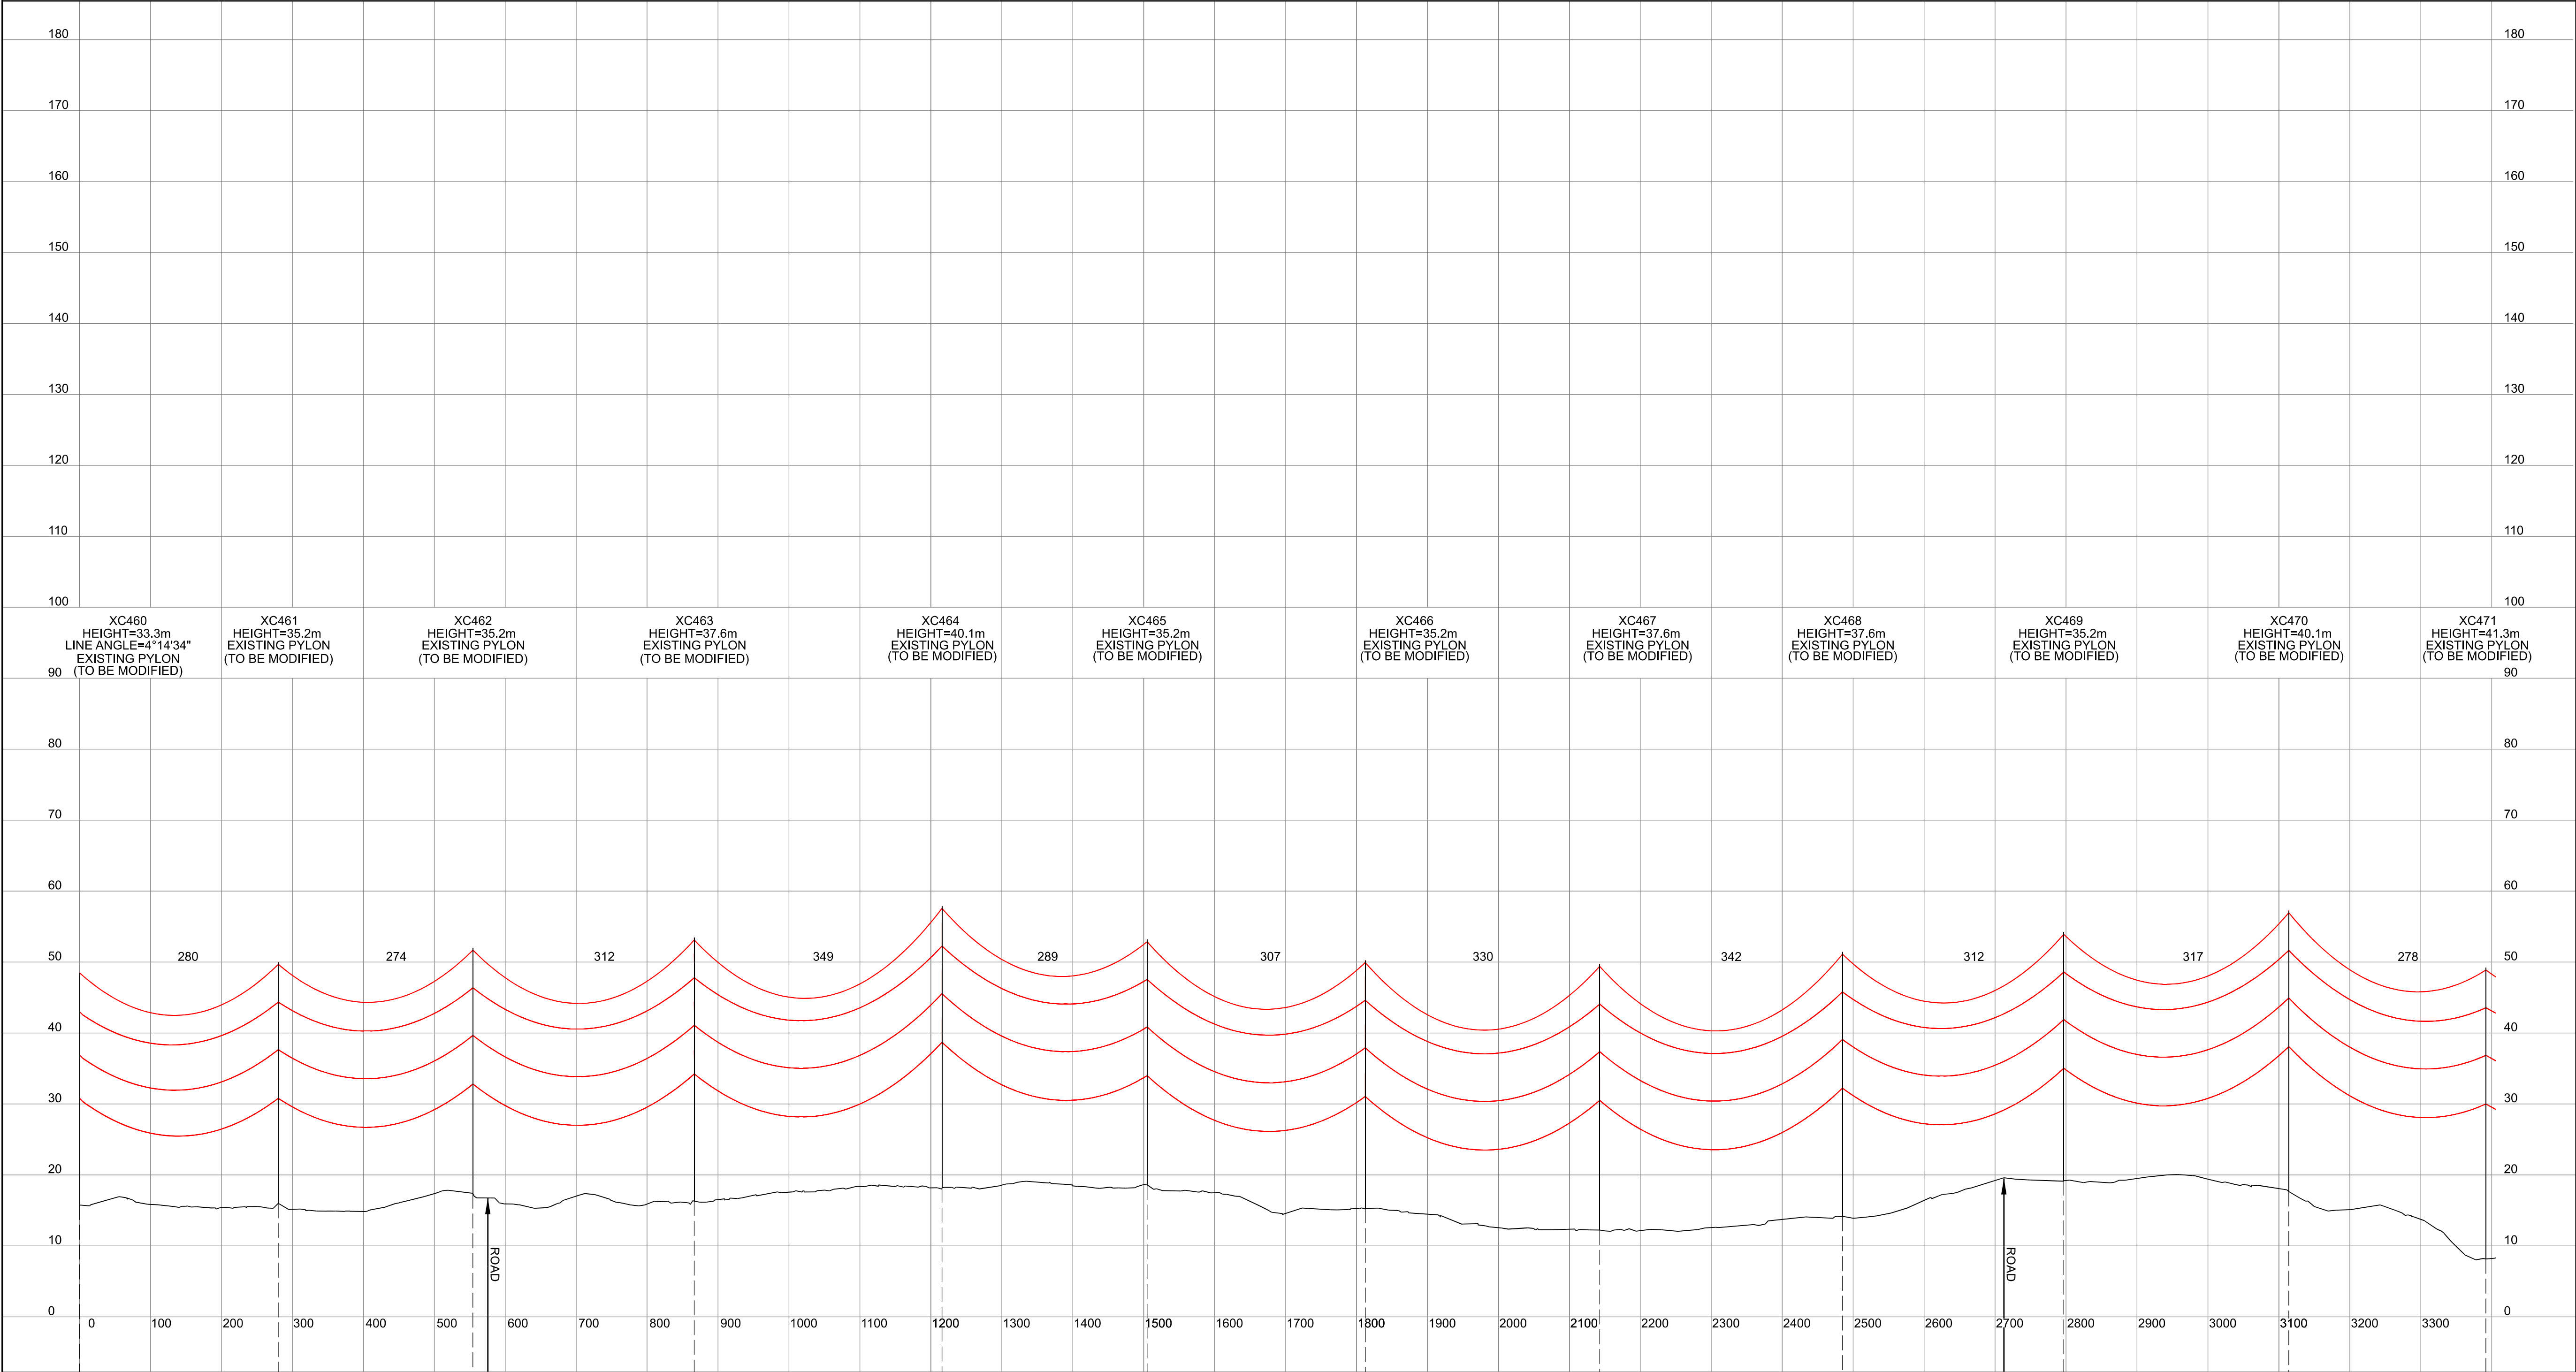Title
NATIONAL GRID
(YORKSHIRE GREEN ENERGY
ENABLEMENT PROJECT) ORDER
DESIGN DRAWING:
INDICATIVE OVERHEAD LINE PROFILE
XC ROUTE
REGULATION 5(2)(o)
SHEET 7 OF 14

nationalgrid

Application Number EN020024					
National Grid Drawing Reference DCO_DE/PS/06_07					
Scale H = 1:5000 V = 1:500	Sheet Size A1	Sheet SHEET 7 OF 14	Issue A		

Legend



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A	01/11/2022	FOR DCO SUBMISSION	FE	SF	EM
Issue	Date	Remarks	Drawn	Checked	Approved

INDICATIVE OVERHEAD LINE PROFILE
XC ROUTE
REGULATION 5(2)(o)
SHEET 8 OF 14

nationalgrid

Application Number


EN020024

Additional Grid Drawing Reference

DCO_DE/PS/06_08

Hz	Sheet Size	Sheet	Issue
Hz = 1:5000	A1	SHEET 8 OF 14	A

Legend

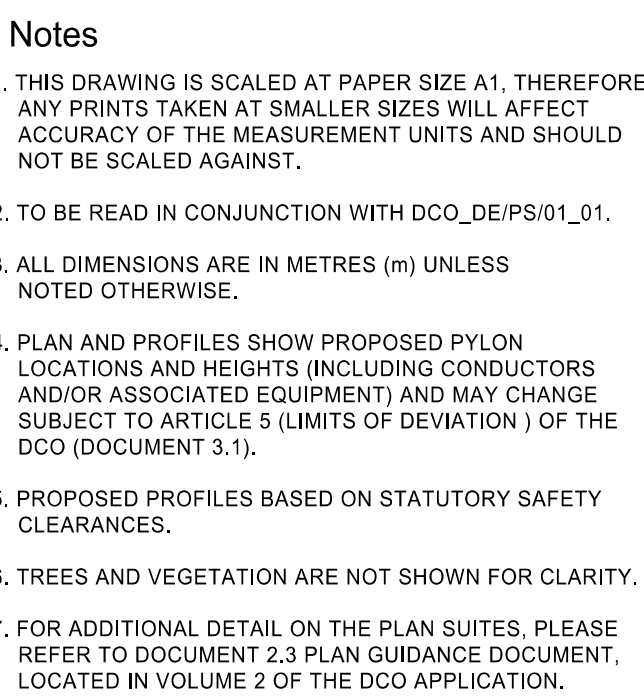

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A	01/11/2022	FOR DCO SUBMISSION	FE	SF	EM
Issue	Date	Remarks	Drawn	Checked	Approved

title NATIONAL GRID
(YORKSHIRE GREEN ENERGY
ENABLEMENT PROJECT) ORDER
DESIGN DRAWING:
INDICATIVE OVERHEAD LINE PROFILE
XC ROUTE
REGULATION 5(2)(o)
SHEET 9 OF 14

nationalgrid



Application Number

EN020024

ational Grid Drawing Reference

<u>Scale</u> H _z = 1:5000 V _{er} t = 1:500	<u>Sheet Size</u> A1	<u>Sheet</u> SHEET 9 OF 14	<u>Issue</u> A
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Legend

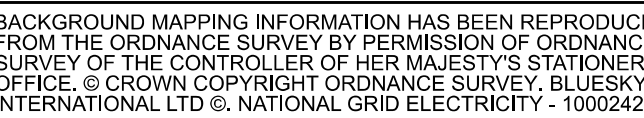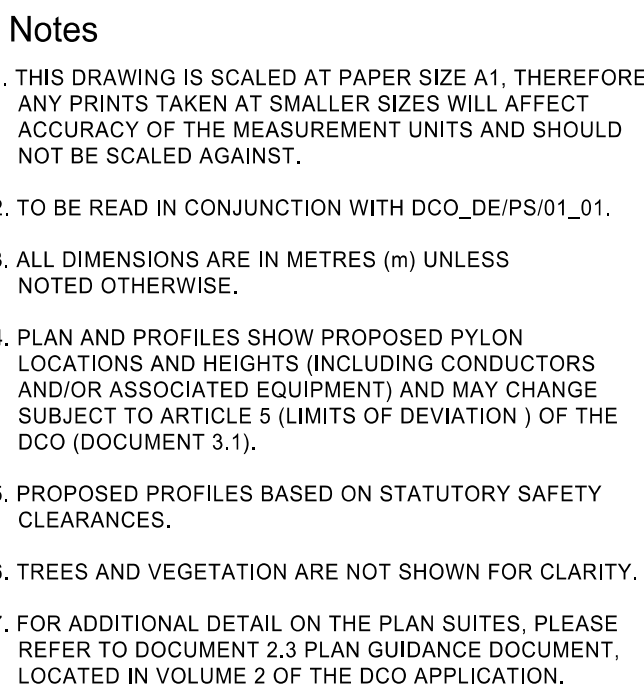

title NATIONAL GRID
(YORKSHIRE GREEN ENERGY
ENABLEMENT PROJECT) ORDER
DESIGN DRAWING:
INDICATIVE OVERHEAD LINE PROFILE
XC ROUTE
REGULATION 5(2)(o)
SHEET 10 OF 14


Application Number

EN020024


International Grid Drawing Reference

<u>Scale</u> H _z = 1:5000 V _{er} t = 1:500	<u>Sheet Size</u> A1	<u>Sheet</u> SHEET 10 OF 14	<u>Issue</u> A
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Legend

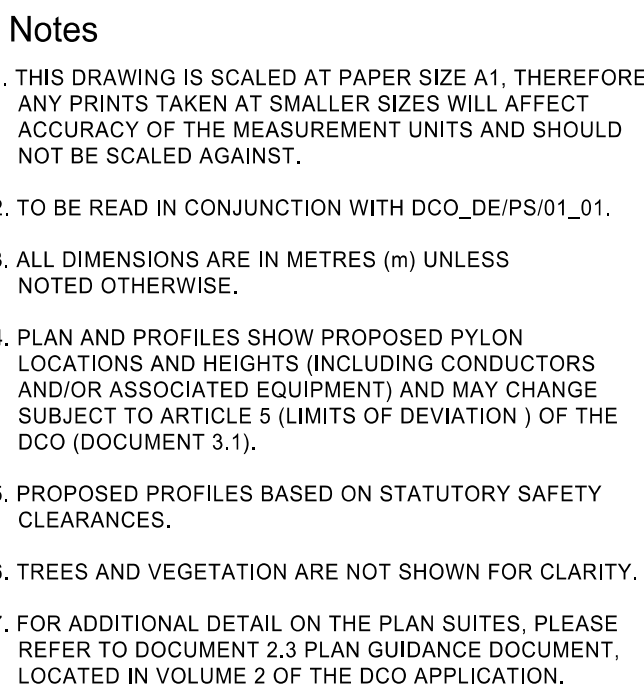

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title

**NATIONAL GRID
(YORKSHIRE GREEN ENERGY
ENABLEMENT PROJECT) ORDER
DESIGN DRAWING:
INDICATIVE OVERHEAD LINE PROFILE
XC ROUTE
REGULATION 5(2)(o)
SHEET 11 OF 14**


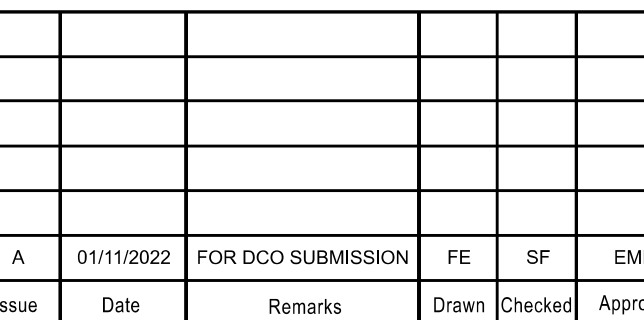
nationalgrid

Application Number: EN000004

ational Grid Drawing Reference

Scale Hz = 1:5000 Vert = 1:500	Sheet Size A1	Sheet SHEET 11 OF 14	Issue A
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Legend

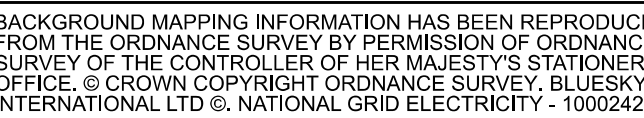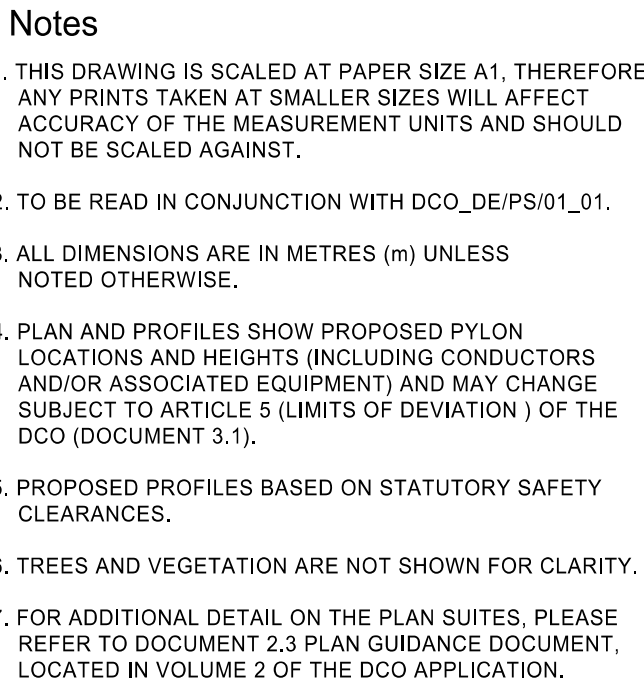

title

NATIONAL GRID
(YORKSHIRE GREEN ENERGY
ENABLEMENT PROJECT) ORDER
DESIGN DRAWING:
INDICATIVE OVERHEAD LINE PROFILE
XC ROUTE
REGULATION 5(2)(o)
SHEET 12 OF 14

Application Number



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DCO_DE/PS/06_12

Scale 1 in. = 1:5000	Sheet Size	Sheet	Issue
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Legend




nationalgrid

EN020024
National Grid Drawing Reference

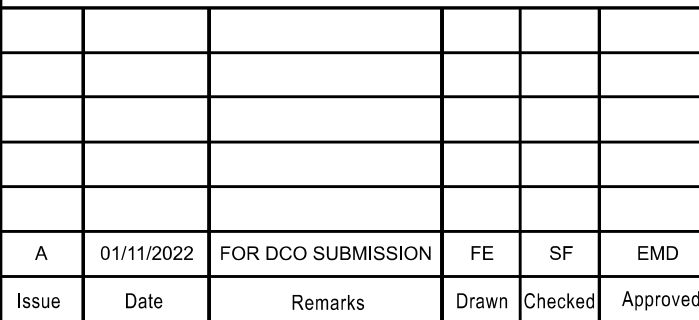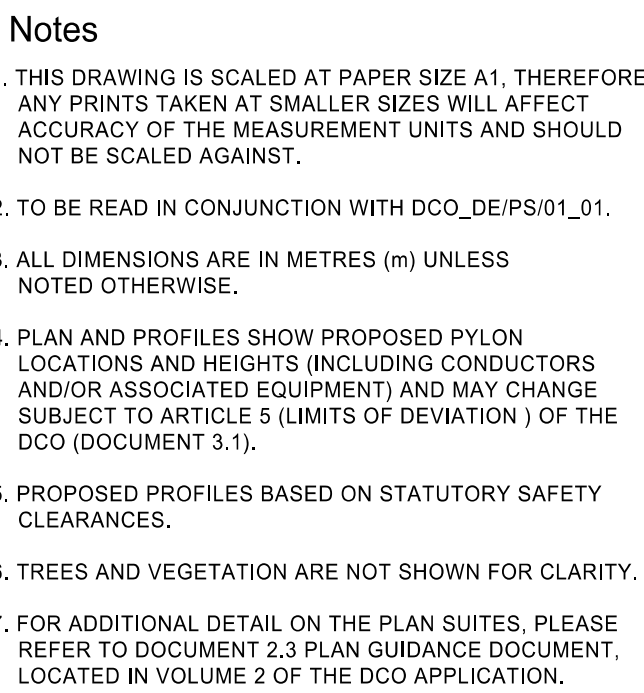Scale Hz = 1:5000	Sheet Size A4	Sheet SHEET 12 OF 14	Issue A
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Legend

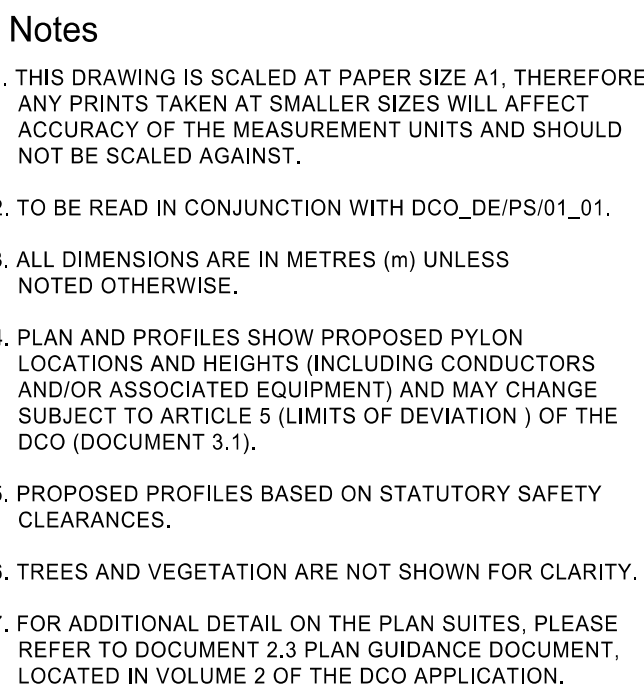

A	01/11/2022	FOR DCO SUBMISSION	FE	SF	EM
Issue	Date	Remarks	Drawn	Checked	Approved


nationalgrid

ational Grid Drawing Reference

<u>Scale</u> Hx = 1:5000 Vx = 1:500	<u>Sheet Size</u> A1	<u>Sheet</u> SHEET 14 OF 14	<u>Issue</u> A
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Legend



**INDICATIVE OVERHEAD LINE PROFILE
XC, XD & PHG ROUTES
REGULATION 5(2)(o)
SHEET 1 OF 2**


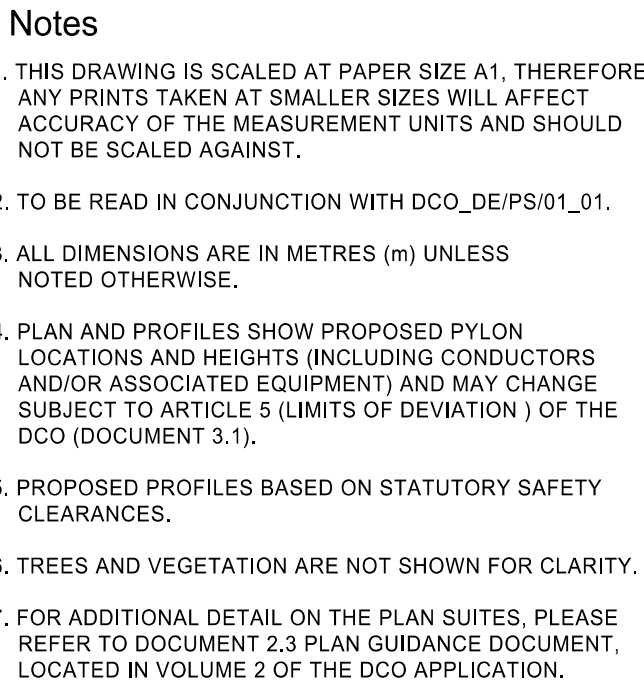
Application Number

EN020024

International Grid Drawing Reference

Scale Hx = 1:5000 Vert = 1:500	Sheet Size A1	Sheet SHEET 1 OF 2	Issue A
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Legend

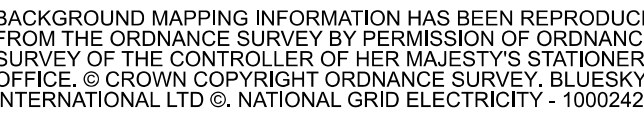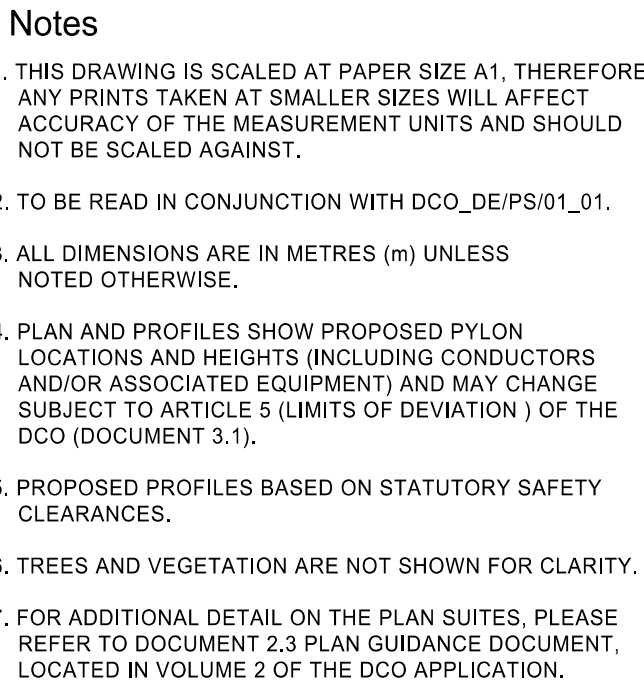

INDICATIVE OVERHEAD LINE PROFILE
XC, XD & PHG ROUTES
REGULATION 5(2)(o)
SHEET 2 OF 2

Application Number

EN020024

ational Grid Drawing Reference


DCO_DE/PS/07_02

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NATIONAL GRID (YORKSHIRE GREEN ENERGY ENABLEMENT PROJECT) ORDER
DESIGN DRAWING: INDICATIVE OVERHEAD LINE PROFILE 4YS & 4ZZ ROUTES
REGULATION 5(2)(o)
SHEET 1 OF 1

Legend

- Notes
1. THIS DRAWING IS SCALED AT PAPER SIZE A1, THEREFORE ANY PRINTS TAKEN AT SMALLER SIZES WILL AFFECT ACCURACY OF THE MEASUREMENT UNITS AND SHOULD NOT BE SCALED AGAINST.
 2. TO BE READ IN CONJUNCTION WITH DCO_DE/PS/01_01.
 3. ALL DIMENSIONS ARE IN METRES (m) UNLESS NOTED OTHERWISE.
 4. PLAN AND PROFILES SHOW PROPOSED PYLON LOCATIONS AND HEIGHTS (INCLUDING CONDUCTORS AND/OR ASSOCIATED EQUIPMENT) AND MAY CHANGE SUBJECT TO ARTICLE 5 (LIMITS OF DEVIATION) OF THE DCO (DOCUMENT 3.1).
 5. PROPOSED PROFILES BASED ON STATUTORY SAFETY CLEARANCES.
 6. TREES AND VEGETATION ARE NOT SHOWN FOR CLARITY.
 7. FOR ADDITIONAL DETAIL ON THE PLAN SUITES, PLEASE REFER TO DOCUMENT 2.3 PLAN GUIDANCE DOCUMENT, LOCATED IN VOLUME 2 OF THE DCO APPLICATION.

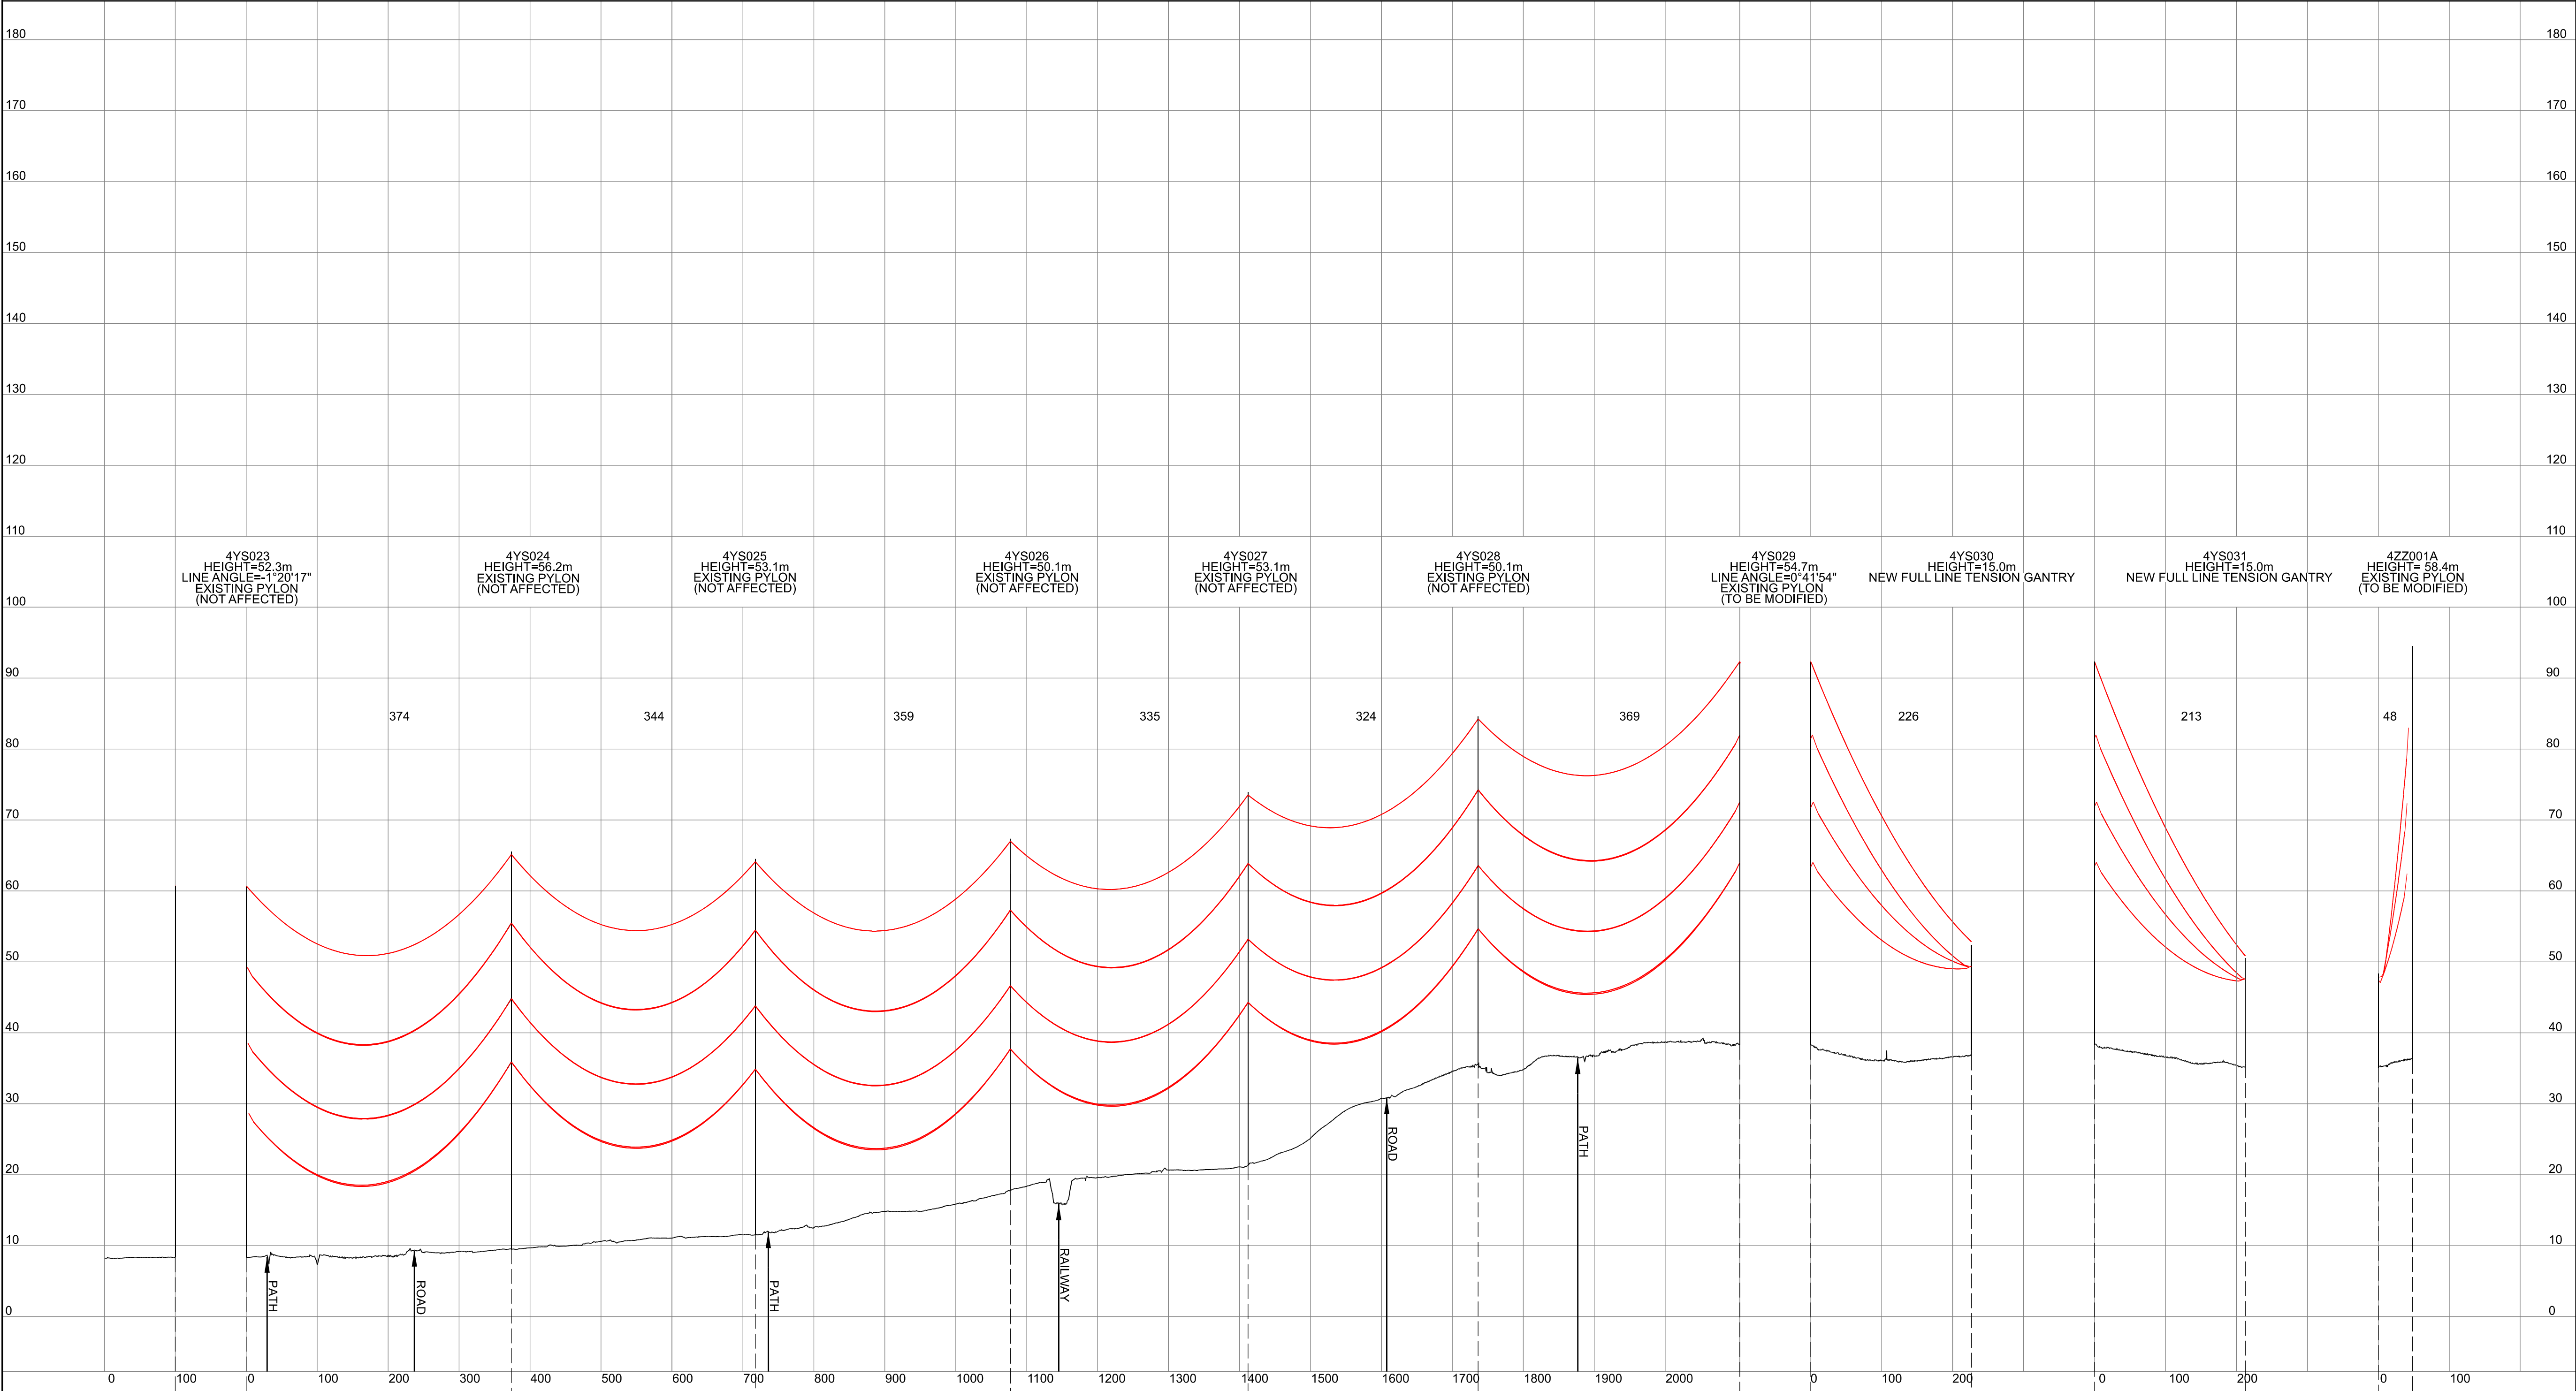

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Issue	Date	Remarks	Drawn	Checked	Approved

Title
NATIONAL GRID
(YORKSHIRE GREEN ENERGY
ENABLEMENT PROJECT) ORDER
DESIGN DRAWING:
INDICATIVE OVERHEAD LINE PROFILE
4YS & 4ZZ ROUTES
REGULATION 5(2)(o)
SHEET 1 OF 1

nationalgrid					
Application Number EN020024					
National Grid Drawing Reference DCO_DE/PS/08_01					
Scale Hz = 1:5000 Vert = 1:500	Sheet Size A1	Sheet SHEET 1 OF 1	Issue A		

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NATIONAL GRID (YORKSHIRE GREEN ENERGY ENABLEMENT PROJECT) ORDER
DESIGN DRAWING: INDICATIVE OVERHEAD LINE PROFILE XC & XCP TEMPORARY ROUTES
REGULATION 5(2)(o)
SHEET 1 OF 1

Legend

- Notes
1. THIS DRAWING IS SCALED AT PAPER SIZE A1, THEREFORE ANY PRINTS TAKEN AT SMALLER SIZES WILL AFFECT ACCURACY OF THE MEASUREMENT UNITS AND SHOULD NOT BE SCALED AGAINST.
 2. TO BE READ IN CONJUNCTION WITH DCO_DE/PS/01_01.
 3. ALL DIMENSIONS ARE IN METRES (m) UNLESS NOTED OTHERWISE.
 4. PLAN AND PROFILES SHOW PROPOSED PYLON LOCATIONS AND HEIGHTS (INCLUDING CONDUCTORS AND/OR ASSOCIATED EQUIPMENT) AND MAY CHANGE SUBJECT TO ARTICLE 5 (LIMITS OF DEVIATION) OF THE DCO (DOCUMENT 3.1).
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Issue	Date	Remarks	Drawn	Checked	Approved


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NATIONAL GRID
(YORKSHIRE GREEN ENERGY
ENABLEMENT PROJECT) ORDER
DESIGN DRAWING:
INDICATIVE OVERHEAD LINE PROFILE
XC & XCP TEMPORARY ROUTES
REGULATION 5(2)(o)
SHEET 1 OF 1

nationalgrid

<u>Application Number</u>		EN020024	
<u>National Grid Drawing Reference</u>			
DCO_DE/PS/09_01			
<u>Scale</u> Hx = 1:5000 Vert = 1:500	<u>Sheet Size</u> A1	<u>Sheet</u> SHEET 1 OF 1	<u>Issue</u> A

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Legend

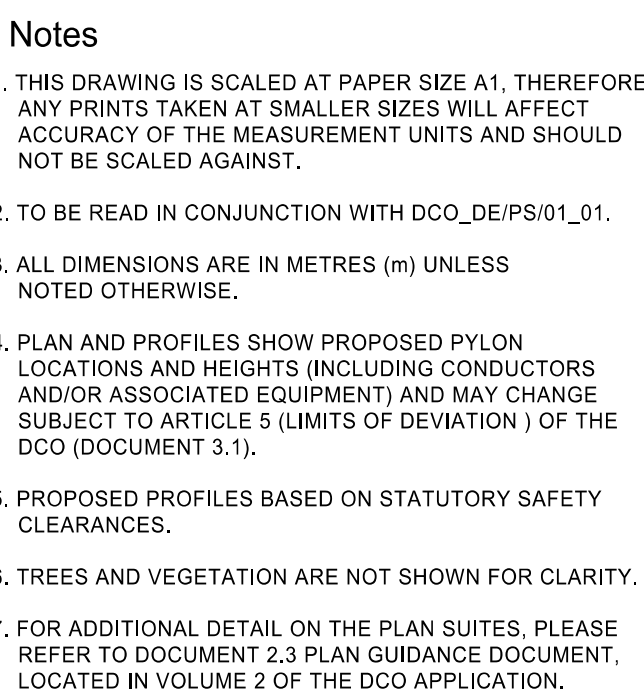


A	01/11/2022	FOR DCO SUBMISSION	FE	SF	EM
Issue	Date	Remarks	Drawn	Checked	Approved

nationalgrid

Optional Grid Drawing Reference

DCO_DE/PS/10_01			
Scale	Sheet Size	Sheet	Issue
Hz = 1:5000 Vert = 1:500	A1	SHEET 1 OF 2	A

Legend

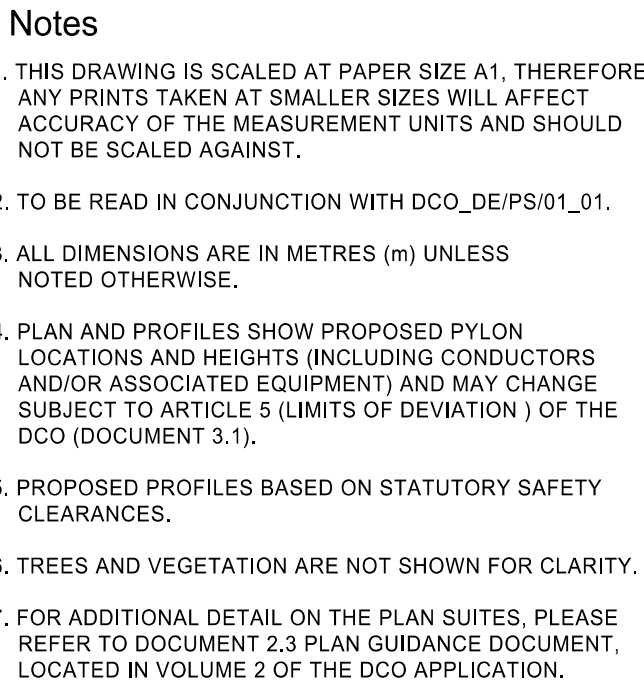

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A	01/11/2022	FOR DCO SUBMISSION	FE	SF	EM
Issue	Date	Remarks	Drawn	Checked	Approved

**INDICATIVE OVERHEAD LINE PROFILE
XC TEMPORARY ROUTE
REGULATION 5(2)(o)
SHEET 2 OF 2**

nationalgrid

Application Number

EN020024

ational Grid Drawing Reference

DCO_DE/PS/10_02


Scale	Sheet Size	Sheet	Issue
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Hz = 1:5000

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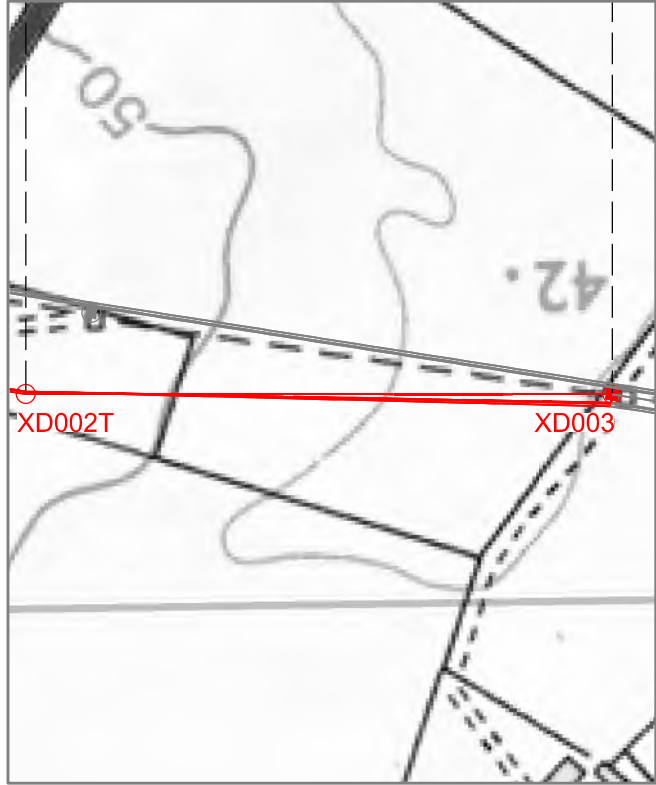
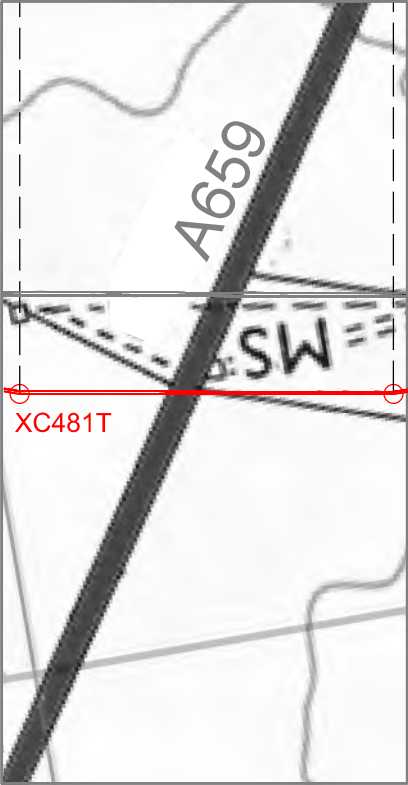
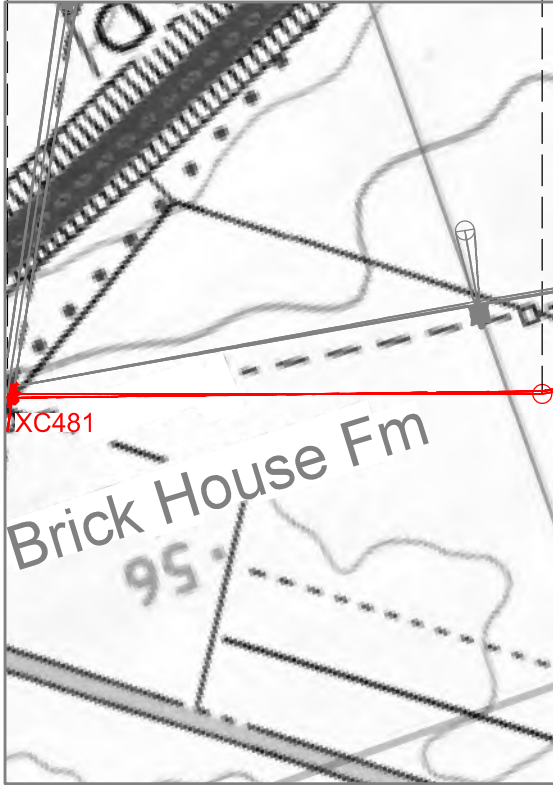
NATIONAL GRID (YORKSHIRE GREEN ENERGY ENABLEMENT PROJECT) ORDER
DESIGN DRAWING: INDICATIVE OVERHEAD LINE PROFILE XC & XD TEMPORARY ROUTES
REGULATION 5(2)(o)
SHEET 1 OF 1

Legend



- Notes**
1. THIS DRAWING IS SCALED AT PAPER SIZE A1, THEREFORE ANY PRINTS TAKEN AT SMALLER SIZES WILL AFFECT ACCURACY OF THE MEASUREMENT UNITS AND SHOULD NOT BE SCALED AGAINST.
 2. TO BE READ IN CONJUNCTION WITH DCO_DE/PS/01_01.
 3. ALL DIMENSIONS ARE IN METRES (m) UNLESS NOTED OTHERWISE.
 4. PLAN AND PROFILES SHOW PROPOSED PYLON LOCATIONS AND HEIGHTS (INCLUDING CONDUCTORS AND/OR ASSOCIATED EQUIPMENT) AND MAY CHANGE SUBJECT TO ARTICLE 5 (LIMITS OF DEVIATION) OF THE DCO (DOCUMENT 3.1).
 5. PROPOSED PROFILES BASED ON STATUTORY SAFETY CLEARANCES.
 6. TREES AND VEGETATION ARE NOT SHOWN FOR CLARITY.
 7. FOR ADDITIONAL DETAIL ON THE PLAN SUITES, PLEASE REFER TO DOCUMENT 2.3 PLAN GUIDANCE DOCUMENT, LOCATED IN VOLUME 2 OF THE DCO APPLICATION.
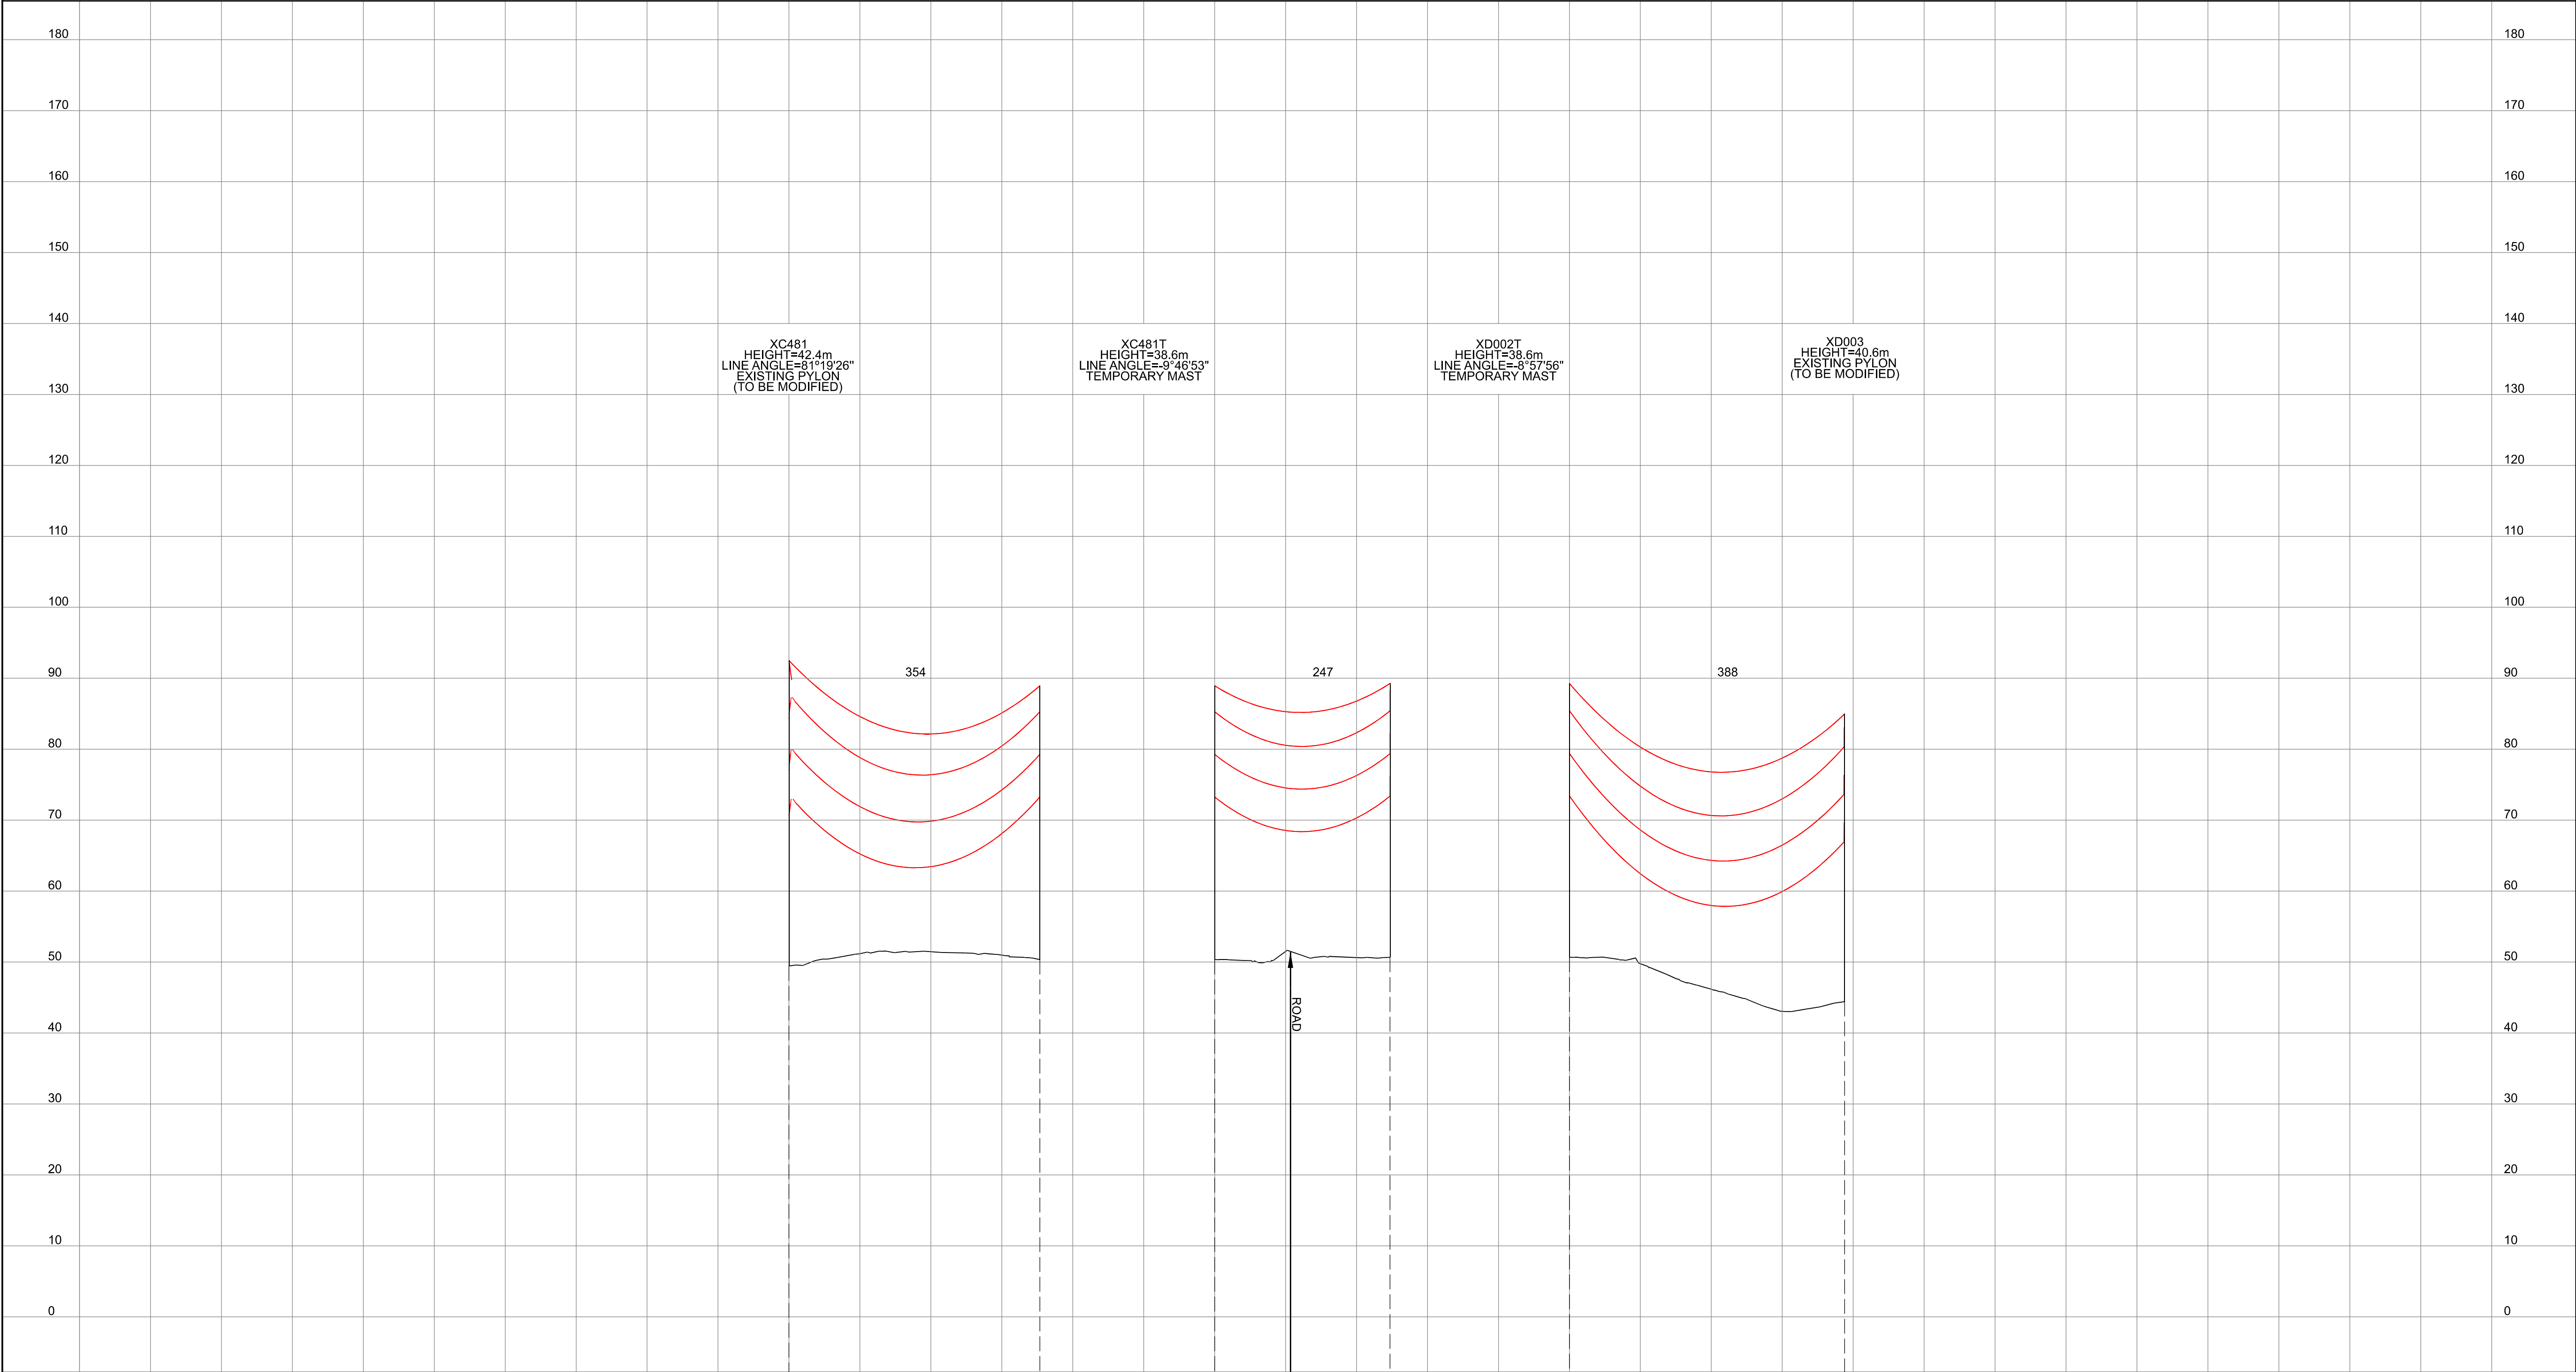
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A	01/11/2022	FOR DCO SUBMISSION	FE	SF	EMD
Issue	Date	Remarks	Drawn	Checked	Approved
Title					
NATIONAL GRID (YORKSHIRE GREEN ENERGY ENABLEMENT PROJECT) ORDER DESIGN DRAWING: INDICATIVE OVERHEAD LINE PROFILE XC & XD TEMPORARY ROUTES REGULATION 5(2)(o) SHEET 1 OF 1					
nationalgrid					
Application Number					
EN020024					
National Grid Drawing Reference					
DCO_DE/PS/11_01					
Scale	Sheet Size	Sheet	Issue		
H _z = 1:5000 Vert = 1:500	A1	SHEET 1 OF 1	A		

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Legend

Notes

THIS DRAWING IS SCALED AT PAPER SIZE A1, THEREFORE ANY PRINTS TAKEN AT SMALLER SIZES WILL AFFECT ACCURACY OF THE MEASUREMENT UNITS AND SHOULD NOT BE SCALED AGAINST.

TO BE READ IN CONJUNCTION WITH DCO_DE/PS/01_01.



ALL DIMENSIONS ARE IN METRES (m) UNLESS NOTED OTHERWISE.

PLAN AND PROFILES SHOW PROPOSED PYLON LOCATIONS AND HEIGHTS (INCLUDING CONDUCTORS AND/OR ASSOCIATED EQUIPMENT) AND MAY CHANGE SUBJECT TO ARTICLE 5 (LIMITS OF DEVIATION) OF THE DCO (DOCUMENT 3.1).

5. PROPOSED PROFILES BASED ON STATUTORY SAFETY CLEARANCES.

5. TREES AND VEGETATION ARE NOT SHOWN FOR CLARITY

FOR ADDITIONAL DETAIL ON THE PLAN SUITES, PLEASE REFER TO DOCUMENT 2.3 PLAN GUIDANCE DOCUMENT LOCATED IN VOLUME 2 OF THE DCO APPLICATION.

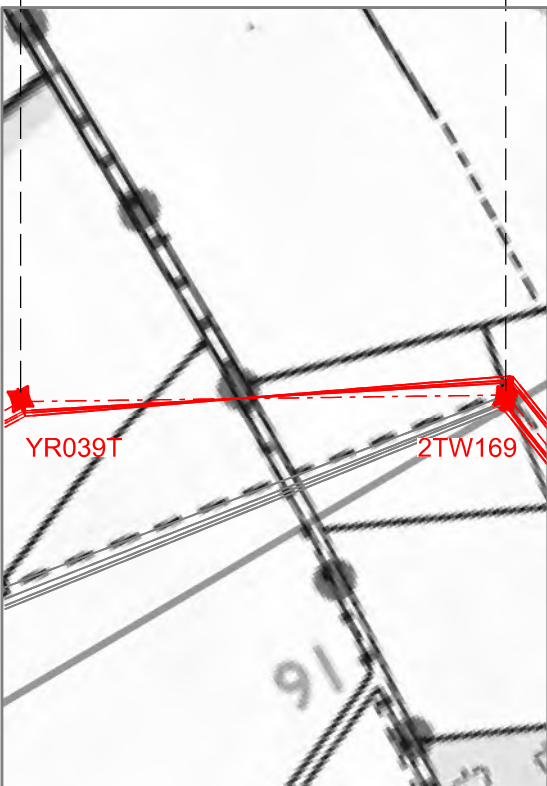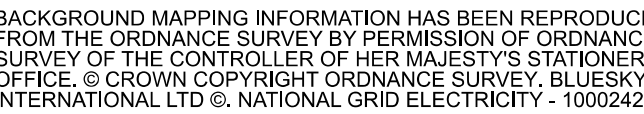

**NATIONAL GRID
(YORKSHIRE GREEN ENERGY
ENABLEMENT PROJECT) ORDER
DESIGN DRAWING:
INDICATIVE OVERHEAD LINE PROFILE
YR & 2TW TEMPORARY ROUTES
REGULATION 5(2)(o)
SHEET 1 OF 1**

nationalgrid

Application Number

EN020024

ational Grid Drawing Reference

DCO DE/PS/12 01

scale

Hz = 1:5000

Sheet Size

A1

Issue

1







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NATIONAL GRID (YORKSHIRE GREEN ENERGY ENABLEMENT PROJECT) ORDER
DESIGN DRAWING: INDICATIVE MAXIMUM AND MINIMUM LATTICE PYLON HEIGHTS
REGULATION 5(2)(o)
SHEET 1 OF 1

Legend

Notes

1. ALL DIMENSIONS ARE INDICATED IN METRES (m) UNLESS NOTED OTHERWISE.
2. THIS DRAWING IS SCALED AT PAPER SIZE A1, THEREFORE ANY PRINTS TAKEN AT SMALLER SIZES WILL AFFECT ACCURACY OF THE MEASUREMENT UNITS AND SHOULD NOT BE SCALED AGAINST.
3. PYLON LEG SPACING AT GROUND LEVEL ASSUMES LEVEL GROUND CONDITIONS.
4. THE MINIMUM AND MAXIMUM HEIGHTS ON THIS DRAWING REPRESENT THE PYLONS FOR THIS PROJECT, HOWEVER THE VALUES HAVE BEEN ROUNDED TO THE NEAREST WHOLE NUMBER FOR CLARITY.
5. ALL PROPOSED PYLONS ARE SUBJECT TO VERTICAL 6m LIMIT OF DEVIATION.
6. FOR ADDITIONAL DETAIL ON THE PLAN SUITES, PLEASE REFER TO DOCUMENT 2.3 PLAN GUIDANCE DOCUMENT, LOCATED IN VOLUME 2 OF THE DCO APPLICATION.

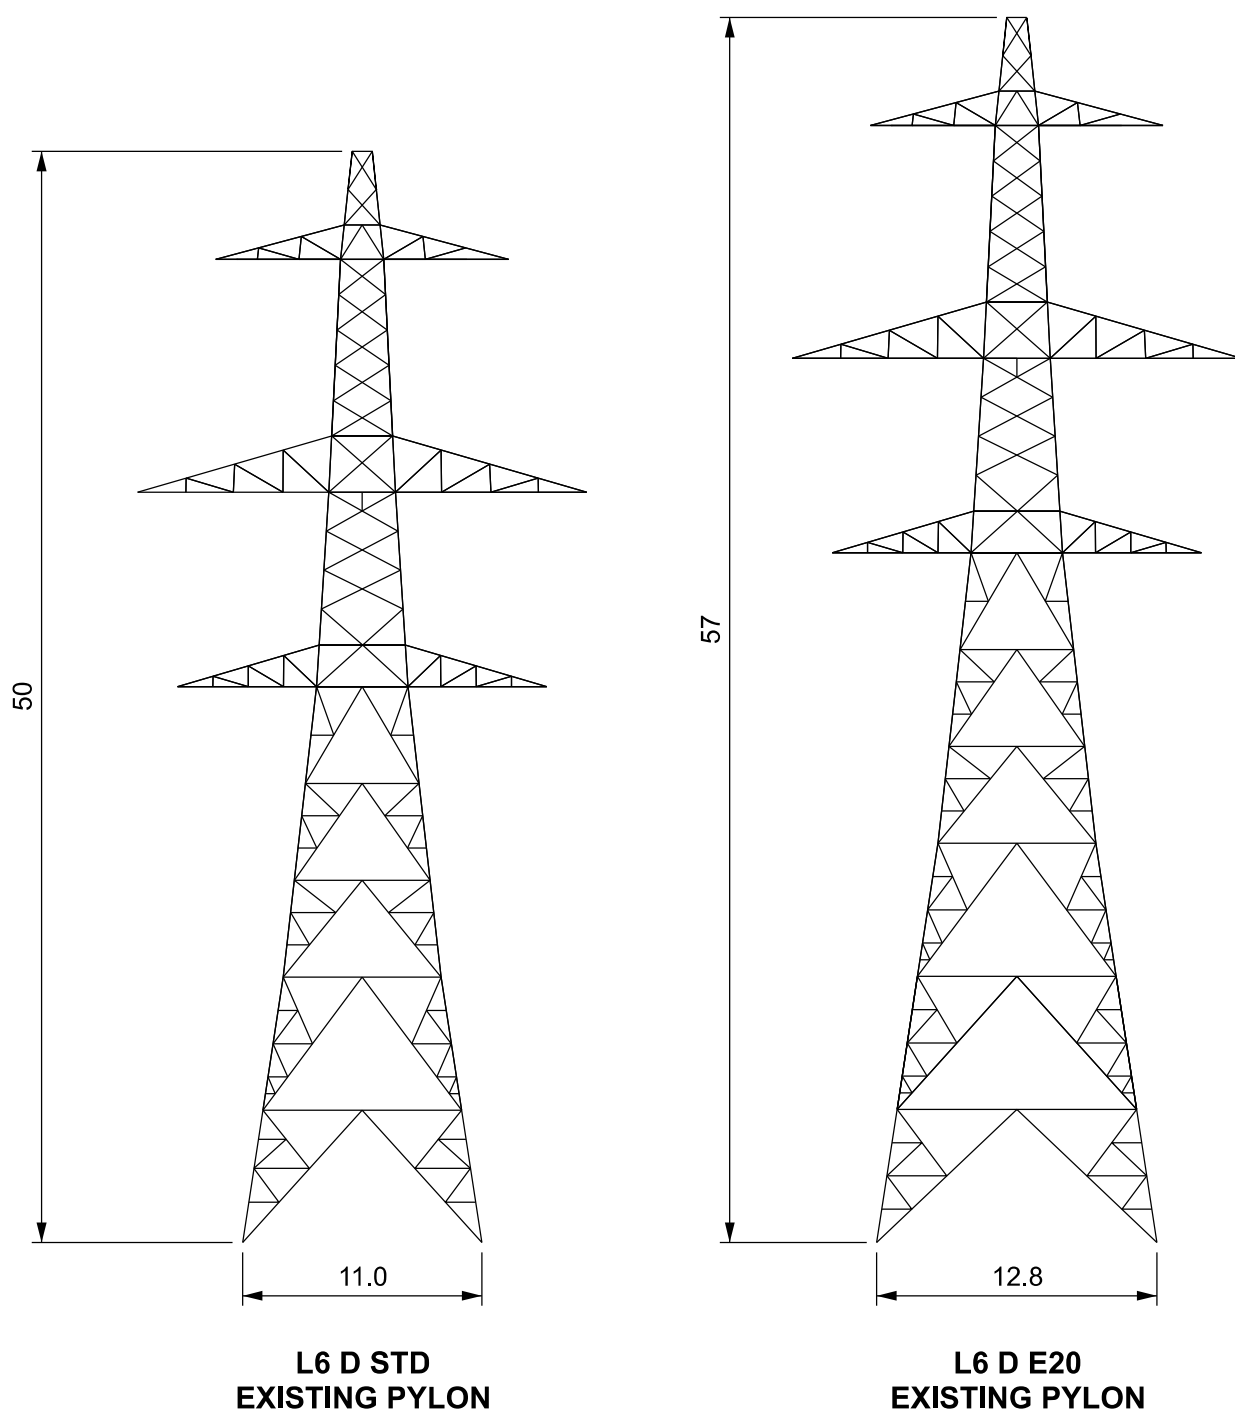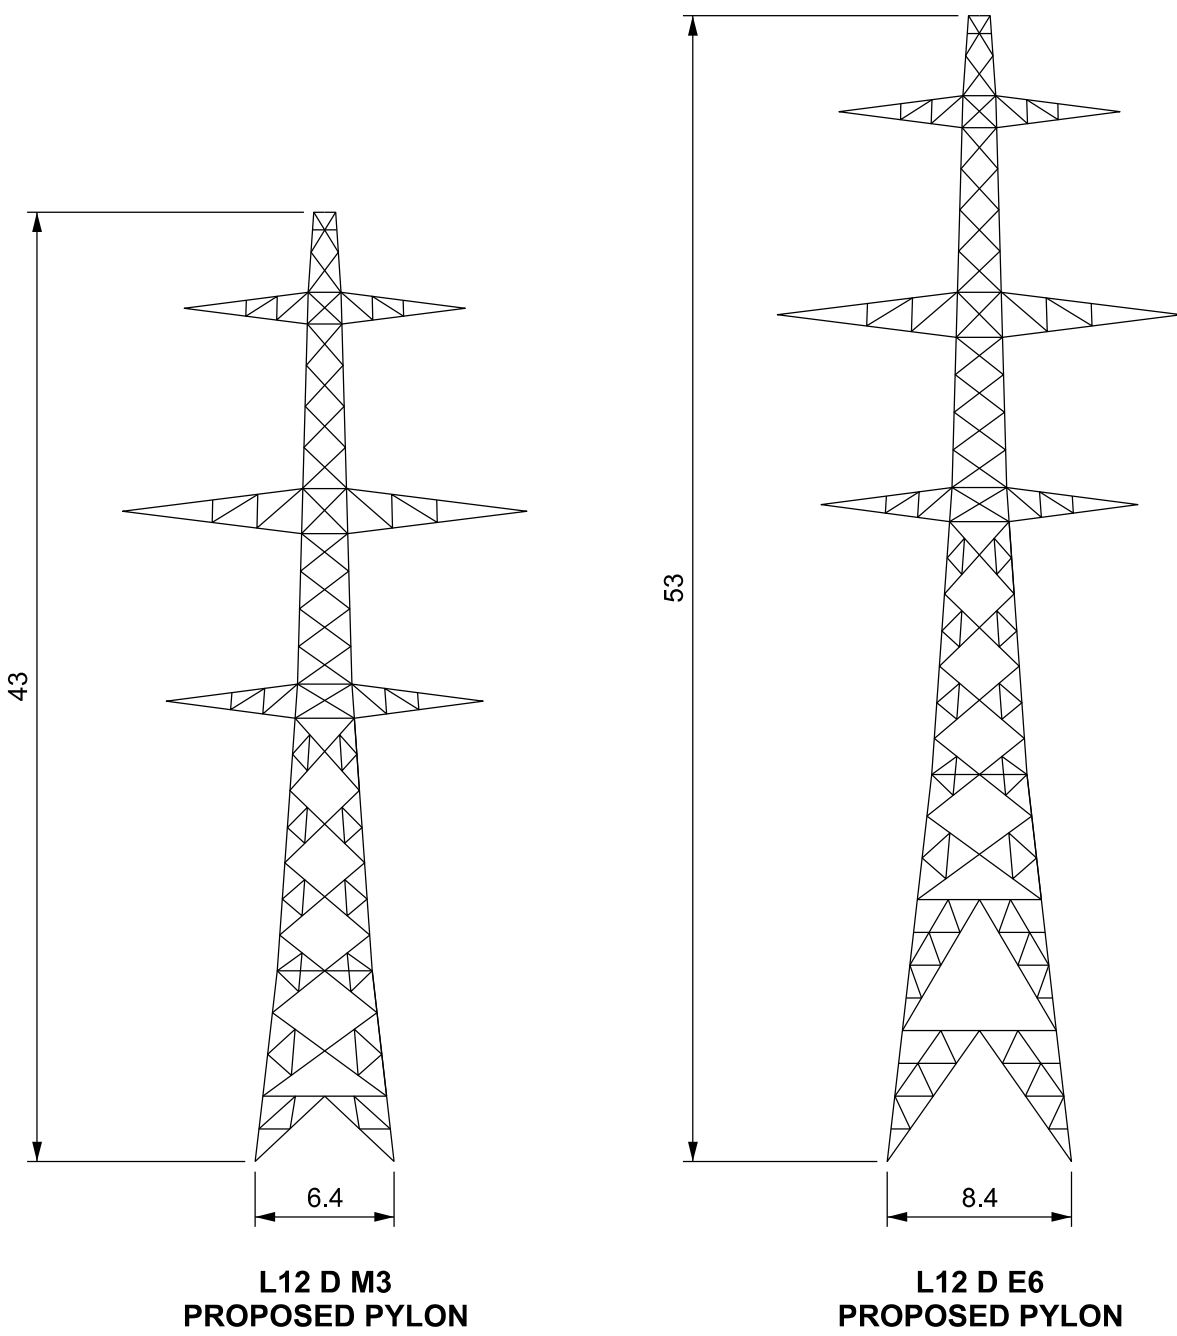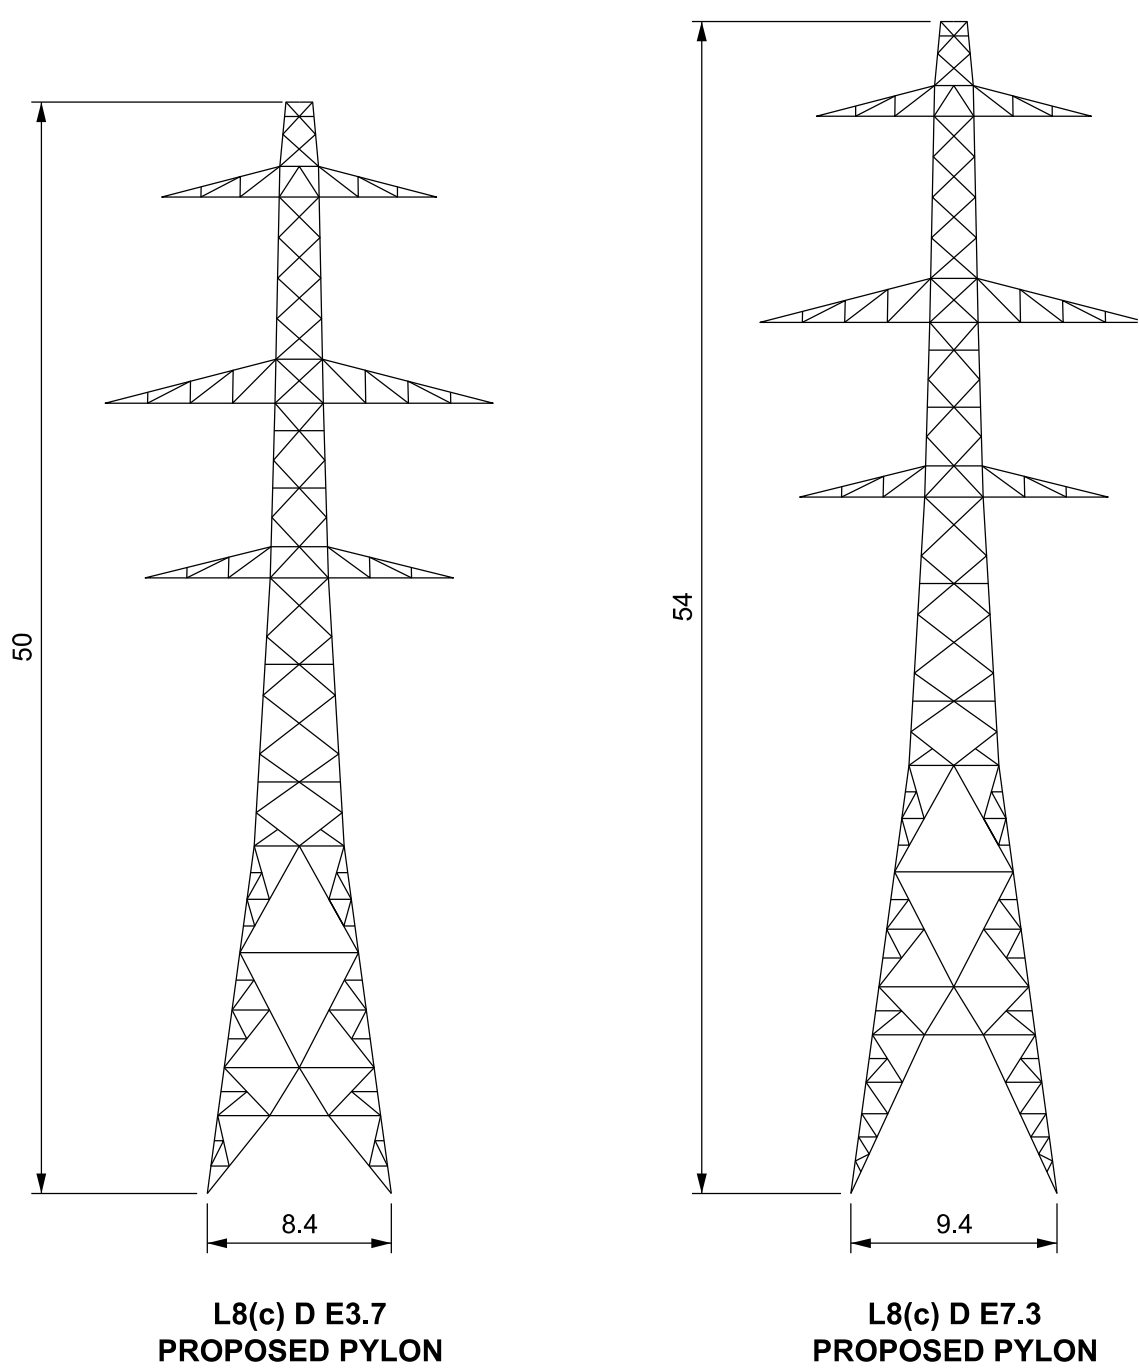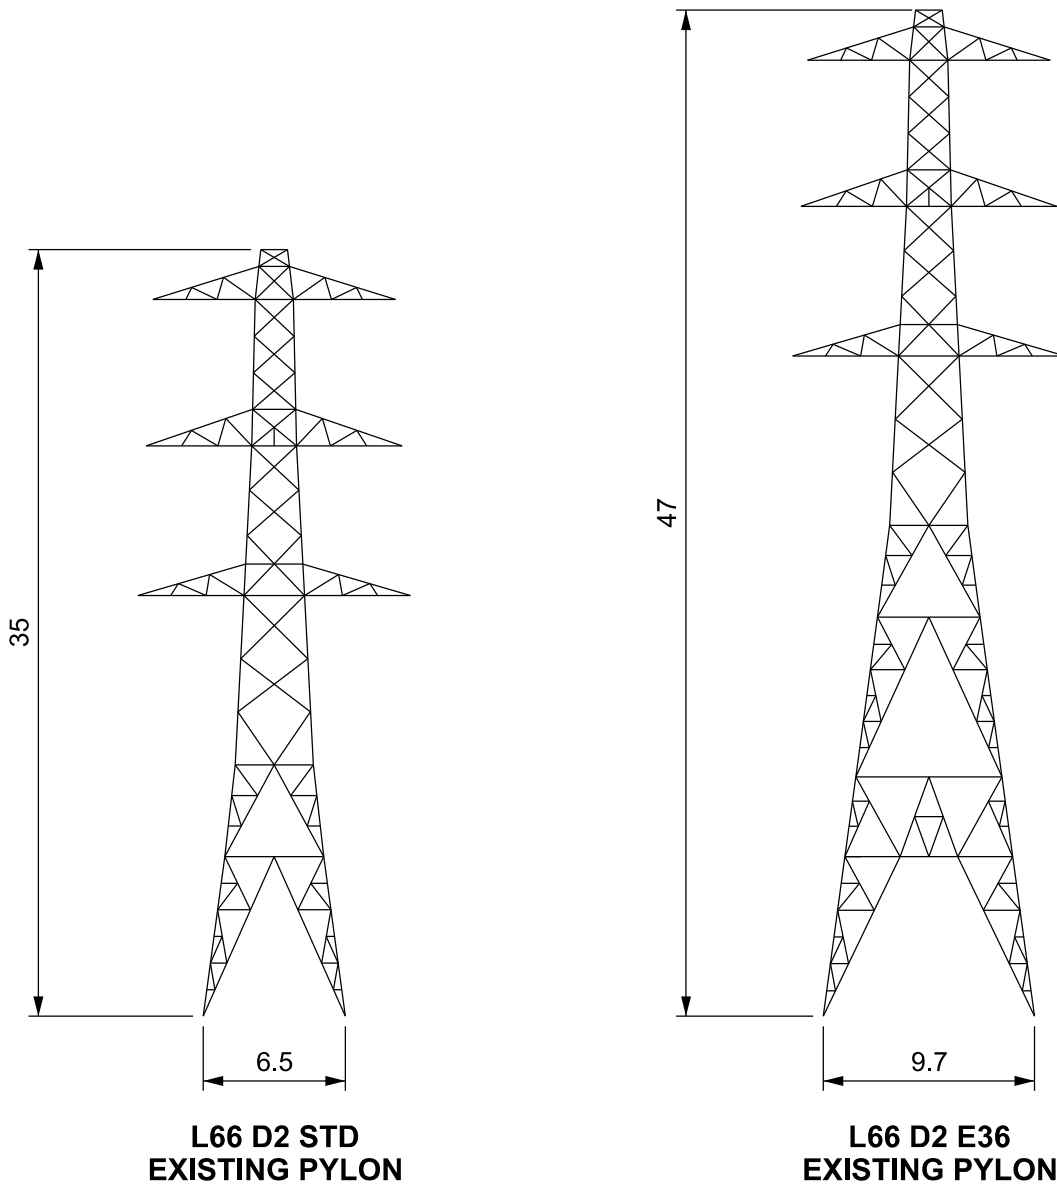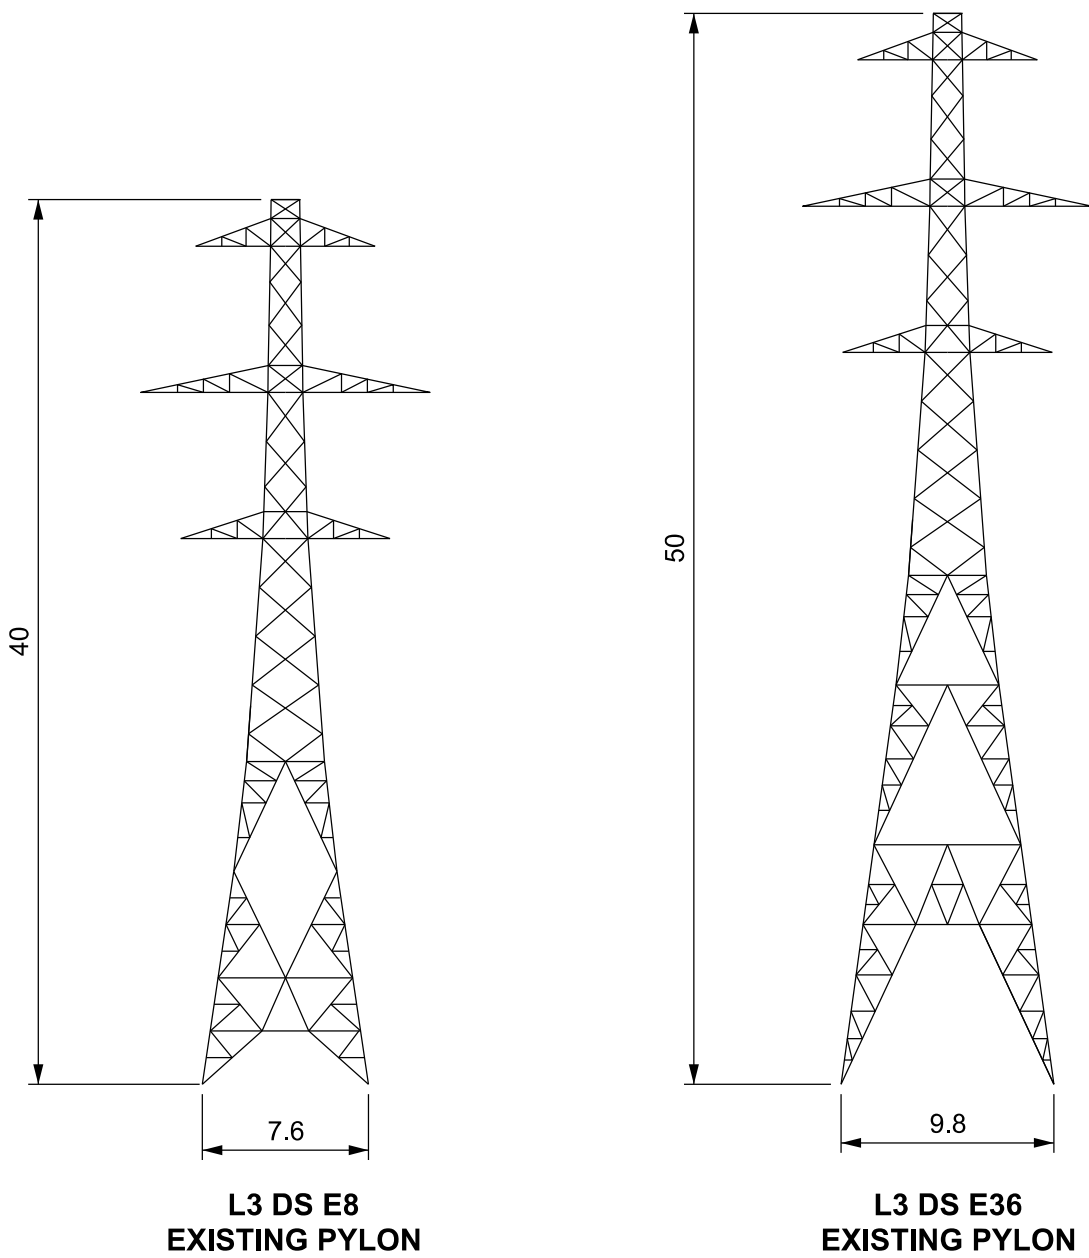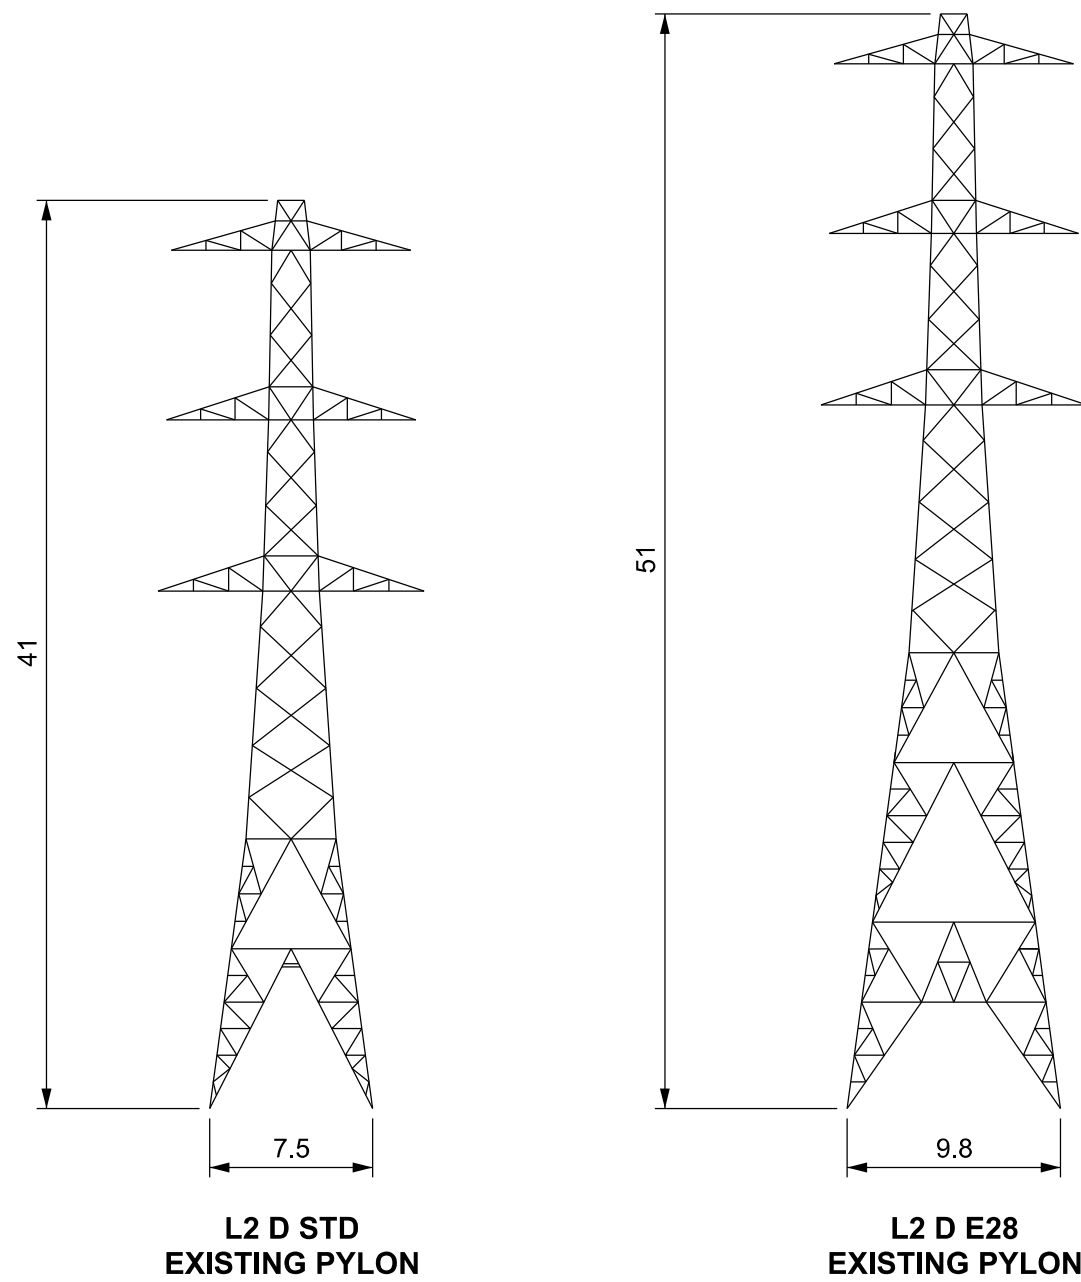

A	01/11/2022	FOR DCO SUBMISSION	AD	SF	EMD
Issue	Date	Remarks	Drawn	Checked	Approved
Title					
NATIONAL GRID (YORKSHIRE GREEN ENERGY ENABLEMENT PROJECT) ORDER DESIGN DRAWING: INDICATIVE MAXIMUM AND MINIMUM LATTICE PYLON HEIGHTS REGULATION 5(2)(o) SHEET 1 OF 1					
nationalgrid					
Application Number					
EN020024					
National Grid Drawing Reference					
DCO_DE/PS/13_01					
Scale	Sheet Size	Sheet	Issue		
N.T.S	A1	SHEET 1 OF 1	A		

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NATIONAL GRID (YORKSHIRE GREEN ENERGY ENABLEMENT PROJECT) ORDER
DESIGN DRAWING: SUBSTATION PARAMETER PLAN - OVERTON
REGULATION 5(2)(o)
SHEET 1 OF 3

Legend

- ORDER LIMITS
- NEW EQUIPMENT, NEW SUBSTATION BOUNDARY & PERIMETER FENCE
- SUBSTATION LIMITS OF DEVIATION
- ZONE WITHIN WHICH FULL LINE TENSION GANTRIES AND NEW EQUIPMENT COULD BE LOCATED - (MAXIMUM HEIGHT - 15m)
- ZONE WITHIN WHICH NEW EQUIPMENT COULD BE LOCATED - (MAXIMUM HEIGHT - 15m)
- ZONE WITHIN WHICH SGT AND NEW EQUIPMENT COULD BE LOCATED - (MAXIMUM HEIGHT - 15m)
- NORTHERN POWERGRID (NORTHEAST) Plc SUBSTATION (MAXIMUM HEIGHT - 5M)
- PERMANENT ACCESS ROAD
- CONTROL BUILDING
- ELEVATION SYMBOL

Notes

- THIS DRAWING IS SCALED AT PAPER SIZE A1. THEREFORE ANY PRINTS TAKEN AT SMALLER SIZES WILL AFFECT ACCURACY OF THE MEASUREMENT UNITS AND SHOULD NOT BE SCALED AGAINST.
- FOR ADDITIONAL DETAIL ON THE PLAN SUITES: PLEASE REFER TO DOCUMENT 2.3 PLAN GUIDANCE DOCUMENT, LOCATED IN VOLUME 2 OF THE DCO APPLICATION.
- NO UNAUTHORISED DISCLOSURE, STORAGE OR COPYING.
- ALL SPATIAL COORDINATES RELATE TO THE ORDNANCE SURVEY, BRITISH NATIONAL GRID (OSGB36).


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Sheet Y Centroid Coordinate: 457492
BACKGROUND MAPPING INFORMATION HAS BEEN REPRODUCED FROM THE ORDNANCE SURVEY BY PERMISSION OF ORDNANCE SURVEY OF THE CONTROLLER OF HER MAJESTY'S STATIONERY OFFICE. © CROWN OFFICE COPYRIGHT ORDNANCE SURVEY. BLUESKY INTERNATIONAL LTD © NATIONAL GRID ELECTRICITY-100024241.


B	26/04/23	DEADLINE 2 UPDATES	NB	SF	EMD
A	01/11/22	FOR DCO SUBMISSION	NB	SF	EMD
Issue	Date	Remarks	Drawn	Checked	Approved

Title
NATIONAL GRID
(YORKSHIRE GREEN ENERGY
ENABLEMENT PROJECT) ORDER
DESIGN DRAWING: SUBSTATION PARAMETER
PLAN - OVERTON
REGULATION 5(2)(o)
SHEET 1 OF 3

nationalgrid

Application Number		EN020024			
National Grid Drawing Reference		DCO_DE/PS/14_01			
Scale	Sheet Size	Sheet	Issue		
1:1500	A1	SHEET 1 OF 3	B		

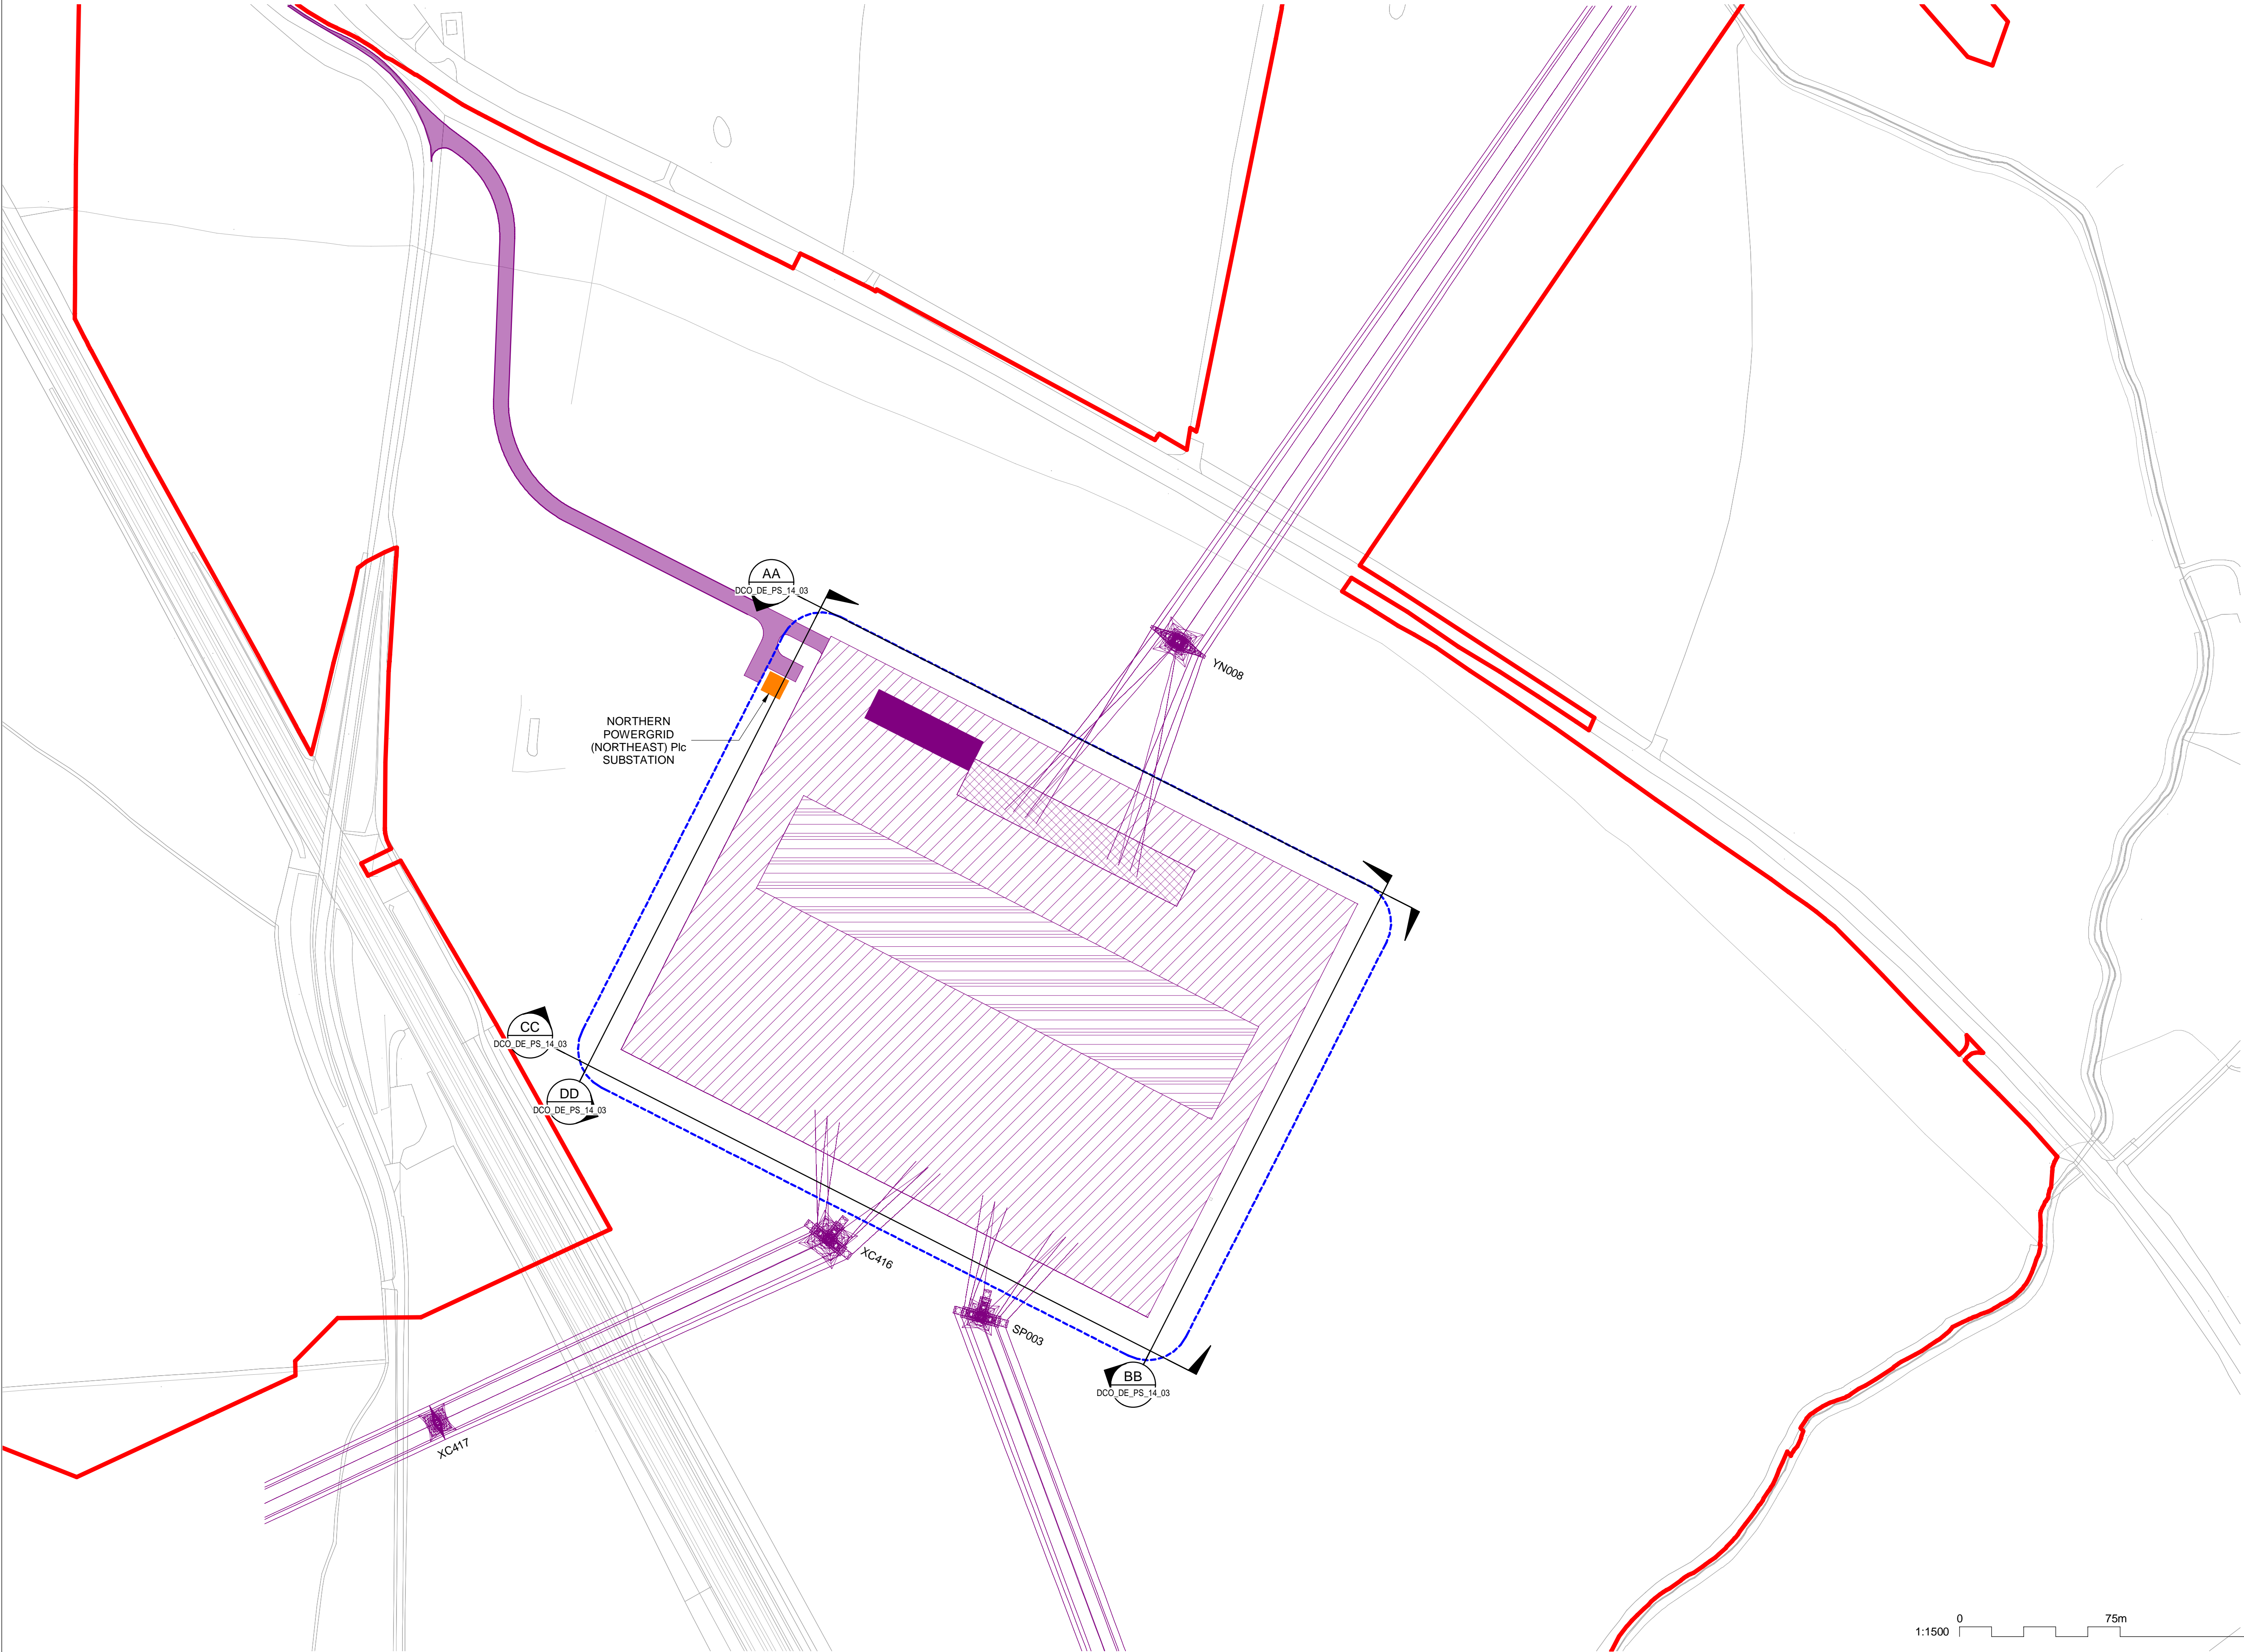

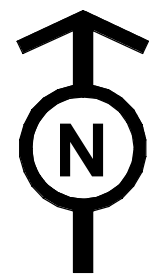

NATIONAL GRID (YORKSHIRE GREEN ENERGY ENABLEMENT PROJECT) ORDER
DESIGN DRAWING: INDICATIVE SUBSTATION LAYOUT - OVERTON
REGULATION 5(2)(o)
SHEET 2 OF 3

Legend

- ORDER LIMITS
- NEW EQUIPMENT
- LIMITS OF DEVIATION
- PERMANENT SUBSTATION DRAINAGE
- PERMANENT LANDSCAPE BUND
- TEMPORARY CONSTRUCTION COMPOUND AND TEMPORARY ACCESS ROAD
- PERMANENT ACCESS ROAD
- TEMPORARY DRAINAGE
- NORTHERN POWERGRID (NORTHEAST) Plc SUBSTATION
- 275KV SINGLE CIRCUIT BREAKER
- 400KV SINGLE CIRCUIT BREAKER
- SINGLE CABLE SEALING END
- 275KV SINGLE CURRENT TRANSFORMER
- 400KV SINGLE CURRENT TRANSFORMER
- SINGLE POST INSULATOR
- SINGLE PANTOGRAPH DISCONNECTOR
- DISCONNECTOR WITH EARTH SWITCH
- FULL LINE TENSION GANTRY
- GANTRY
- EARTH SWITCH
- ELEVATION SYMBOL

Notes


- THIS DRAWING IS SCALED AT PAPER SIZE A1. THEREFORE ANY PRINTS TAKEN AT SMALLER SIZES WILL AFFECT ACCURACY OF THE MEASUREMENT UNITS AND SHOULD NOT BE SCALED AGAINST.
- FOR ADDITIONAL DETAIL ON THE PLAN SUITES, PLEASE REFER TO DOCUMENT 2.3 PLAN GUIDANCE DOCUMENT, LOCATED IN VOLUME 2 OF THE DCO APPLICATION.
- NO UNAUTHORISED DISCLOSURE, STORAGE OR COPYING.
- ALL SPATIAL COORDINATES RELATE TO THE ORDNANCE SURVEY, BRITISH NATIONAL GRID (OSGB36).


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Sheet X Centroid Coordinate: 455754
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B	26/04/23	DEADLINE 2 UPDATES	NB	SF	EMD
A	01/11/22	FOR DCO SUBMISSION	NB	SF	EMD
Issue	Date	Remarks	Drawn	Checked	Approved

Title
NATIONAL GRID
(YORKSHIRE GREEN ENERGY
ENABLEMENT PROJECT) ORDER
DESIGN DRAWING: INDICATIVE SUBSTATION
LAYOUT - OVERTON
REGULATION 5(2)(o)
SHEET 2 OF 3


nationalgrid					
Application Number					
EN020024					
National Grid Drawing Reference					
DCO_DE/PS/14_02					
Scale	Sheet Size	Sheet	Issue		
1:1500	A1	SHEET 2 OF 3	B		



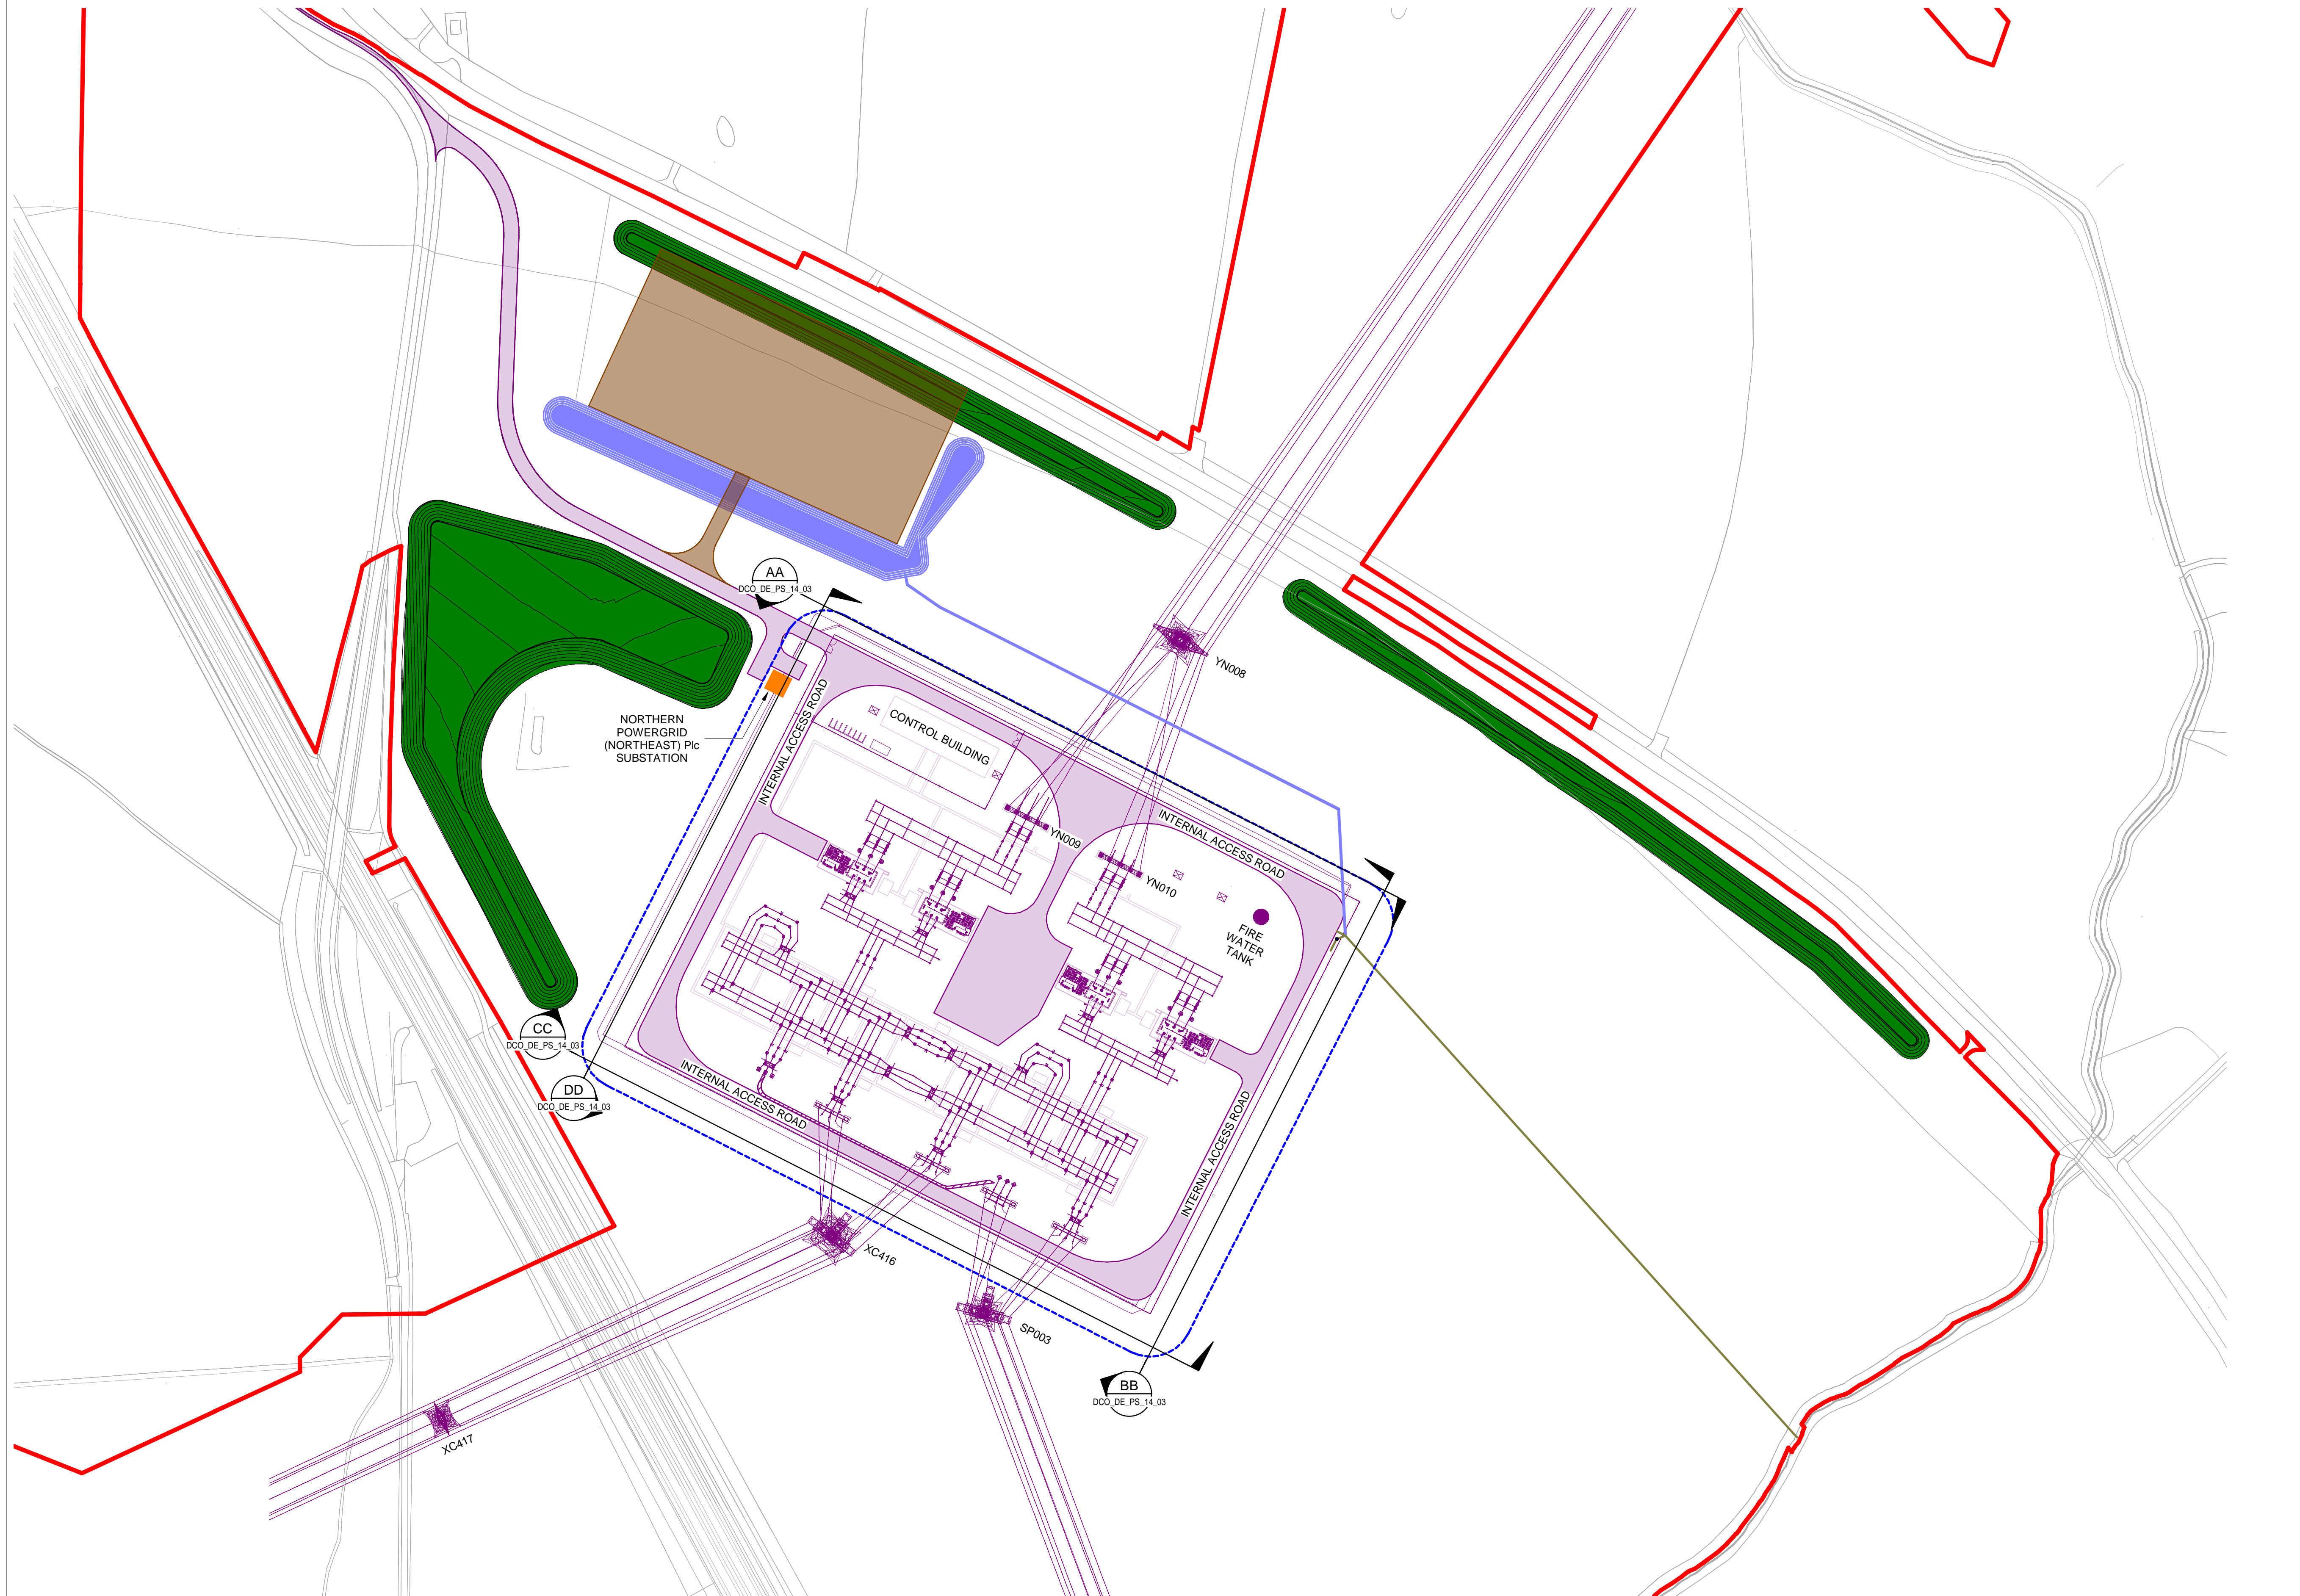

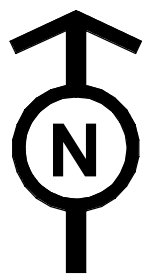
NATIONAL GRID (YORKSHIRE GREEN ENERGY ENABLEMENT PROJECT) ORDER
DESIGN DRAWING: INDICATIVE SUBSTATION ELEVATION - OVERTON
REGULATION 5(2)(o)
SHEET 3 OF 3

Legend

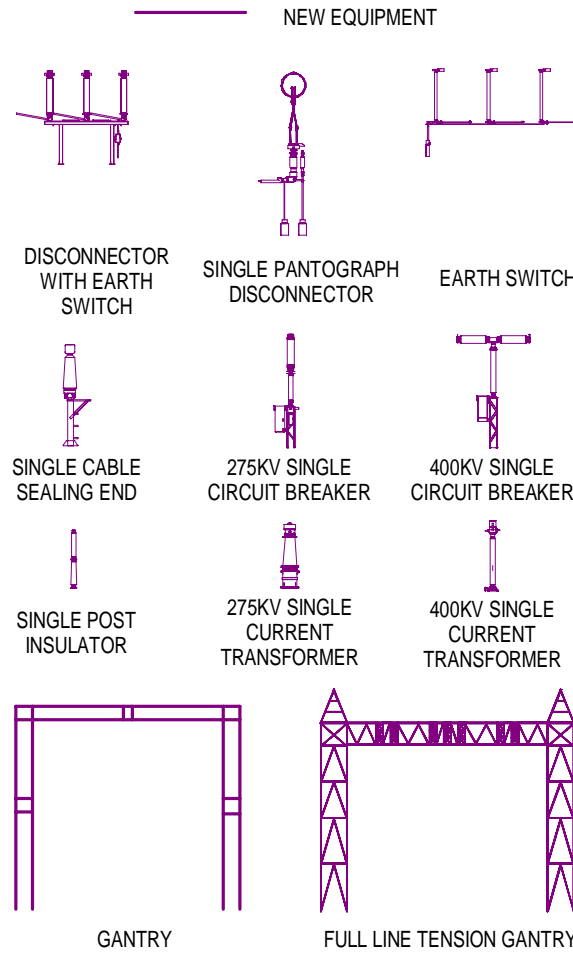


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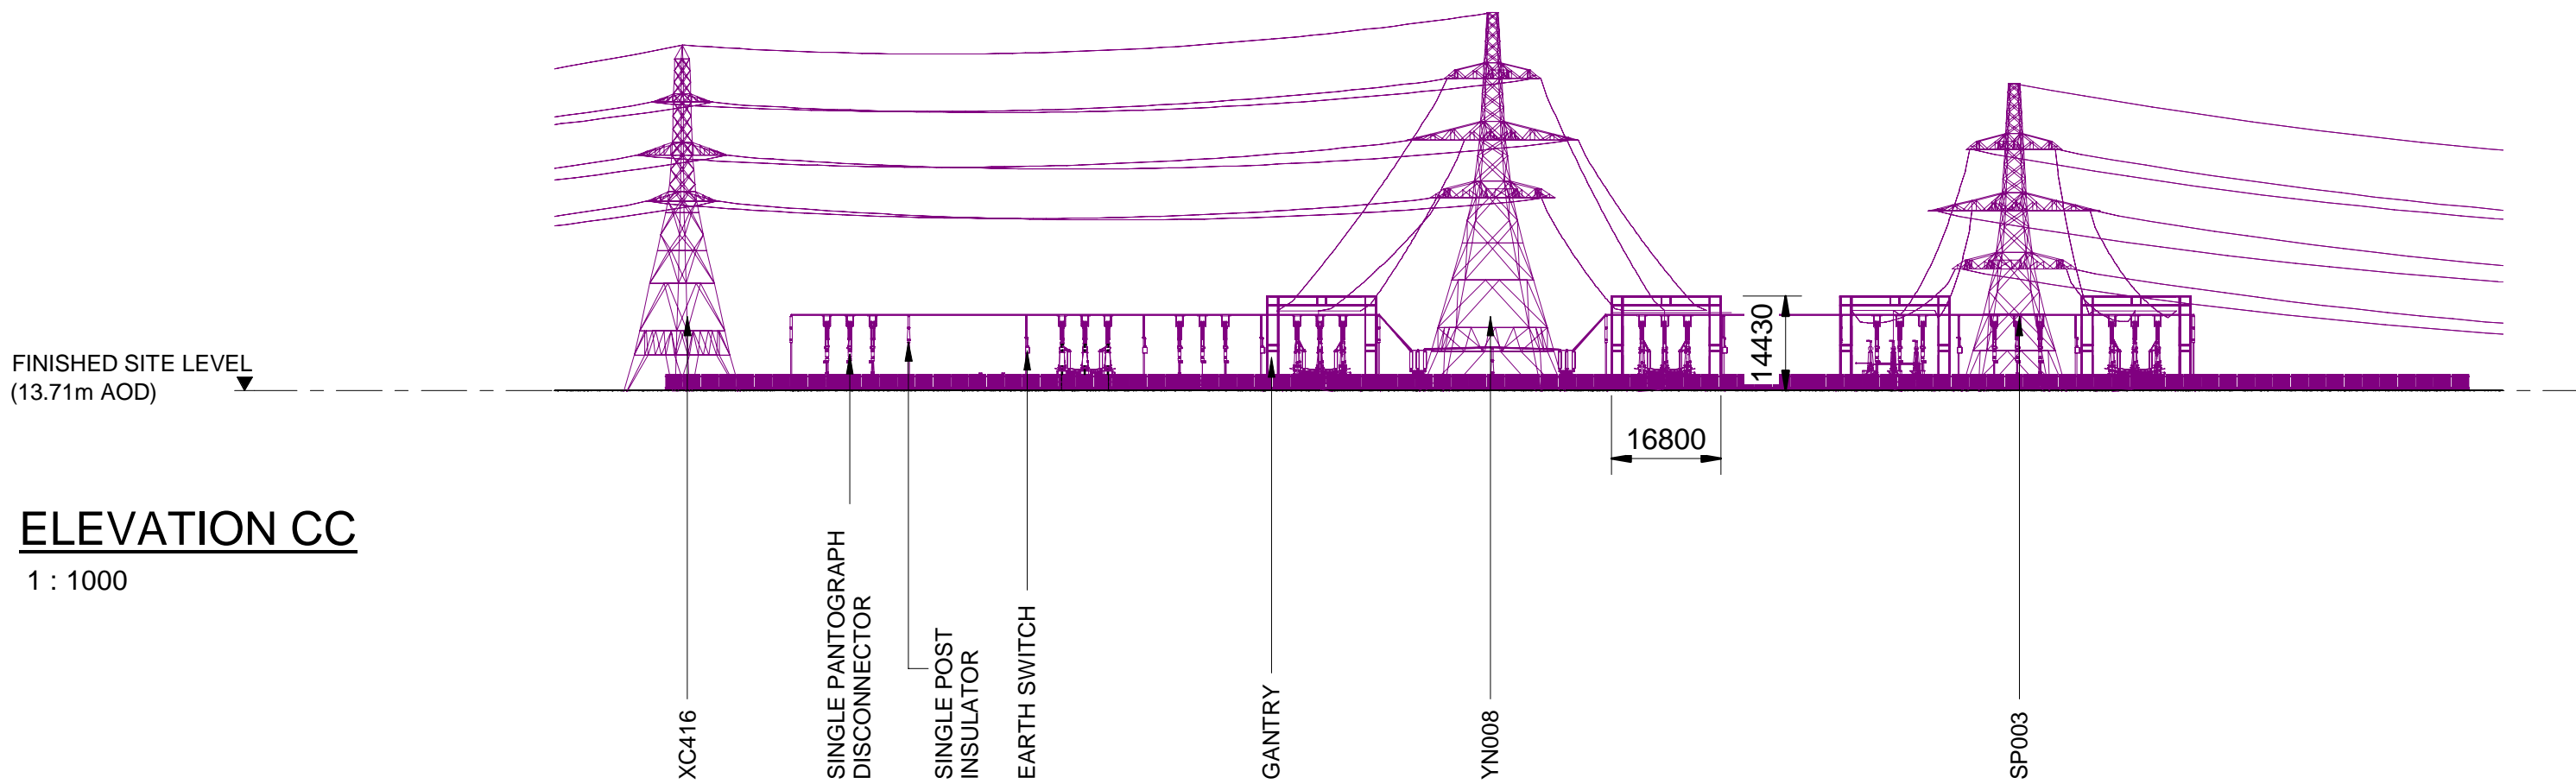
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2. FOR ADDITIONAL DETAIL ON THE PLAN SUITES, PLEASE REFER TO DOCUMENT 2.3 PLAN GUIDANCE DOCUMENT, LOCATED IN VOLUME 2 OF THE DCO APPLICATION.
3. ALL DIMENSIONS ARE IN MILLIMETRES UNLESS OTHERWISE STATED.
4. NO UNAUTHORISED DISCLOSURE, STORAGE OR COPYING.
5. ALL SPATIAL COORDINATES RELATE TO THE ORDNANCE SURVEY, BRITISH NATIONAL GRID (OSGB36).

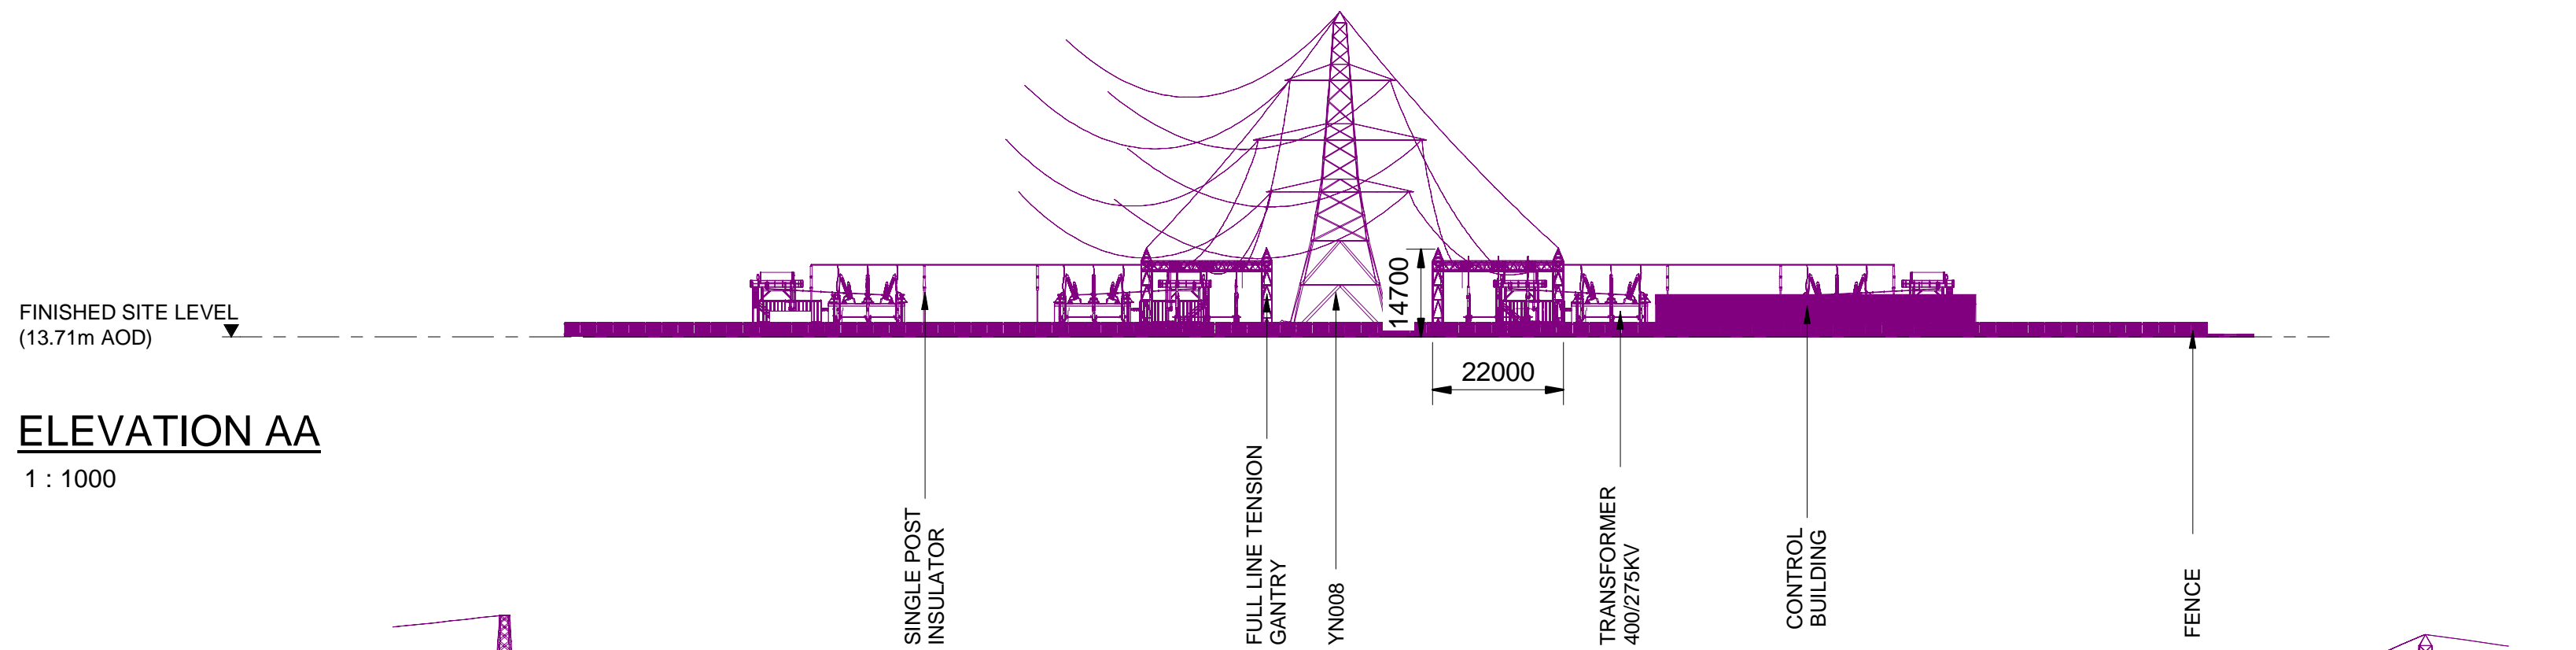


ELEVATION AA
1 : 1000

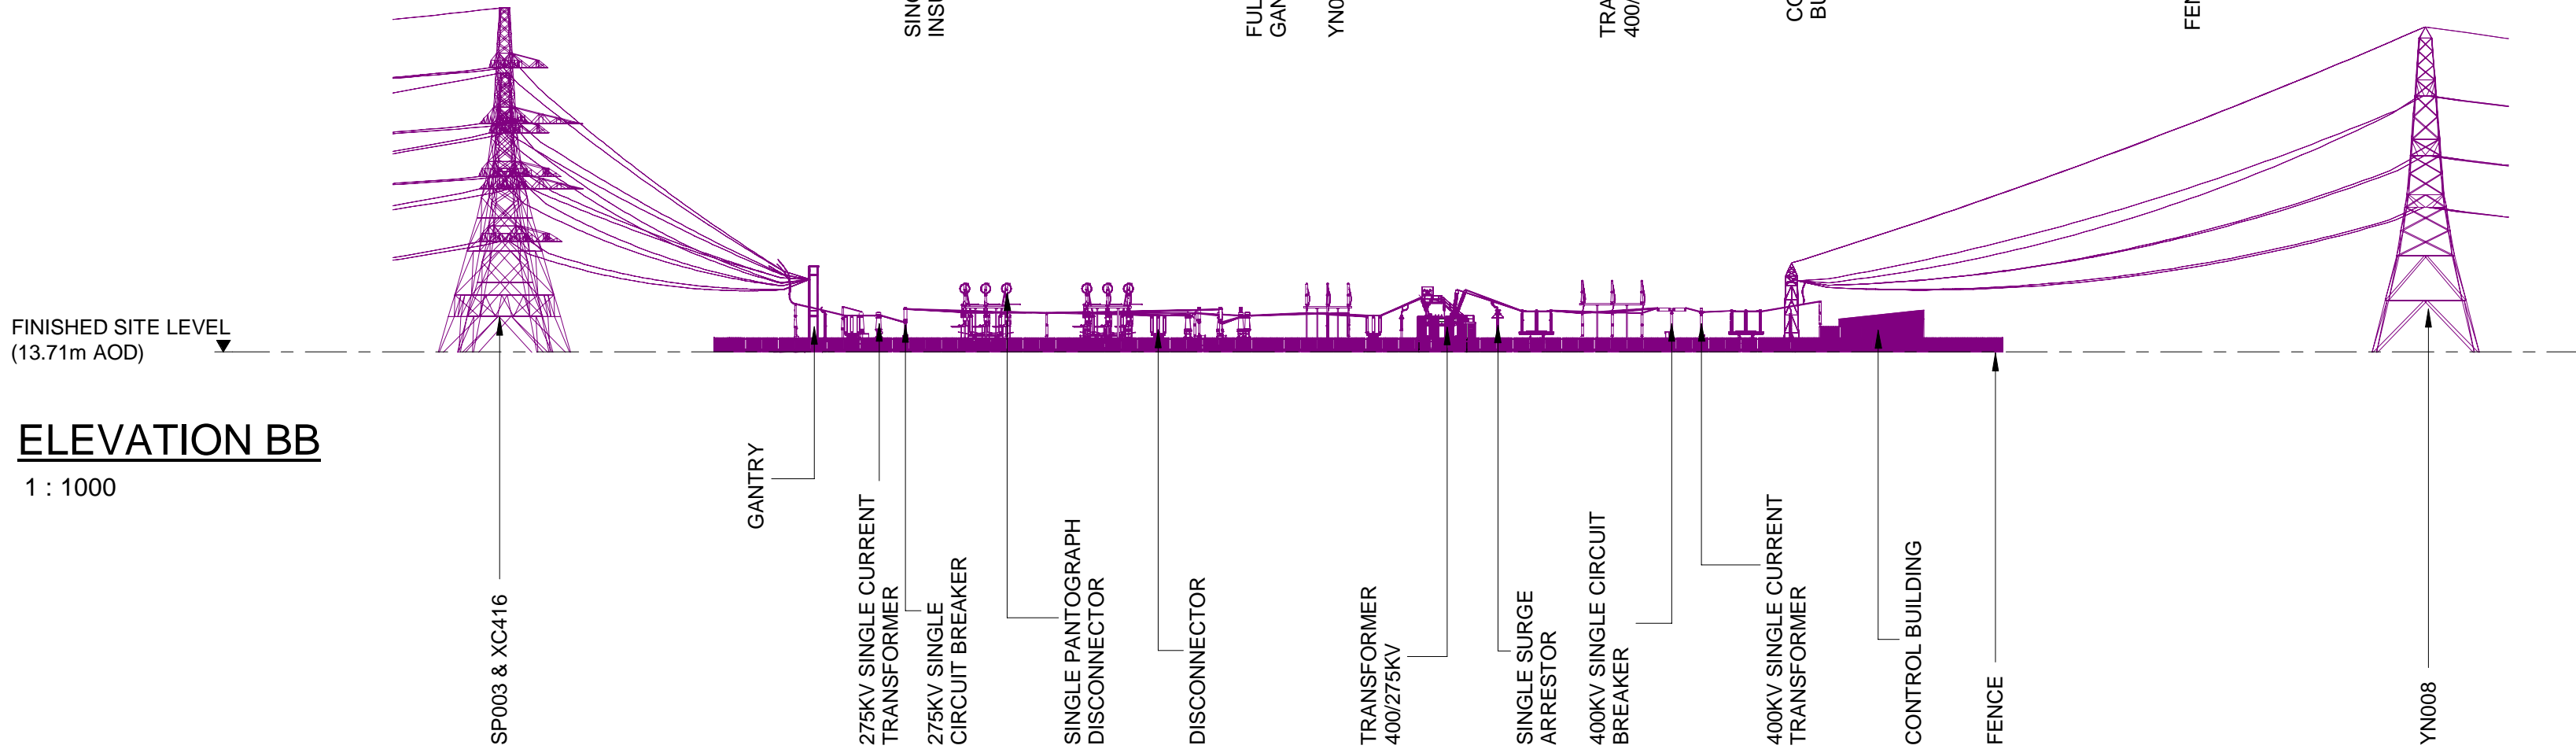


ELEVATION BB
1 : 1000



ELEVATION CC
1 : 1000

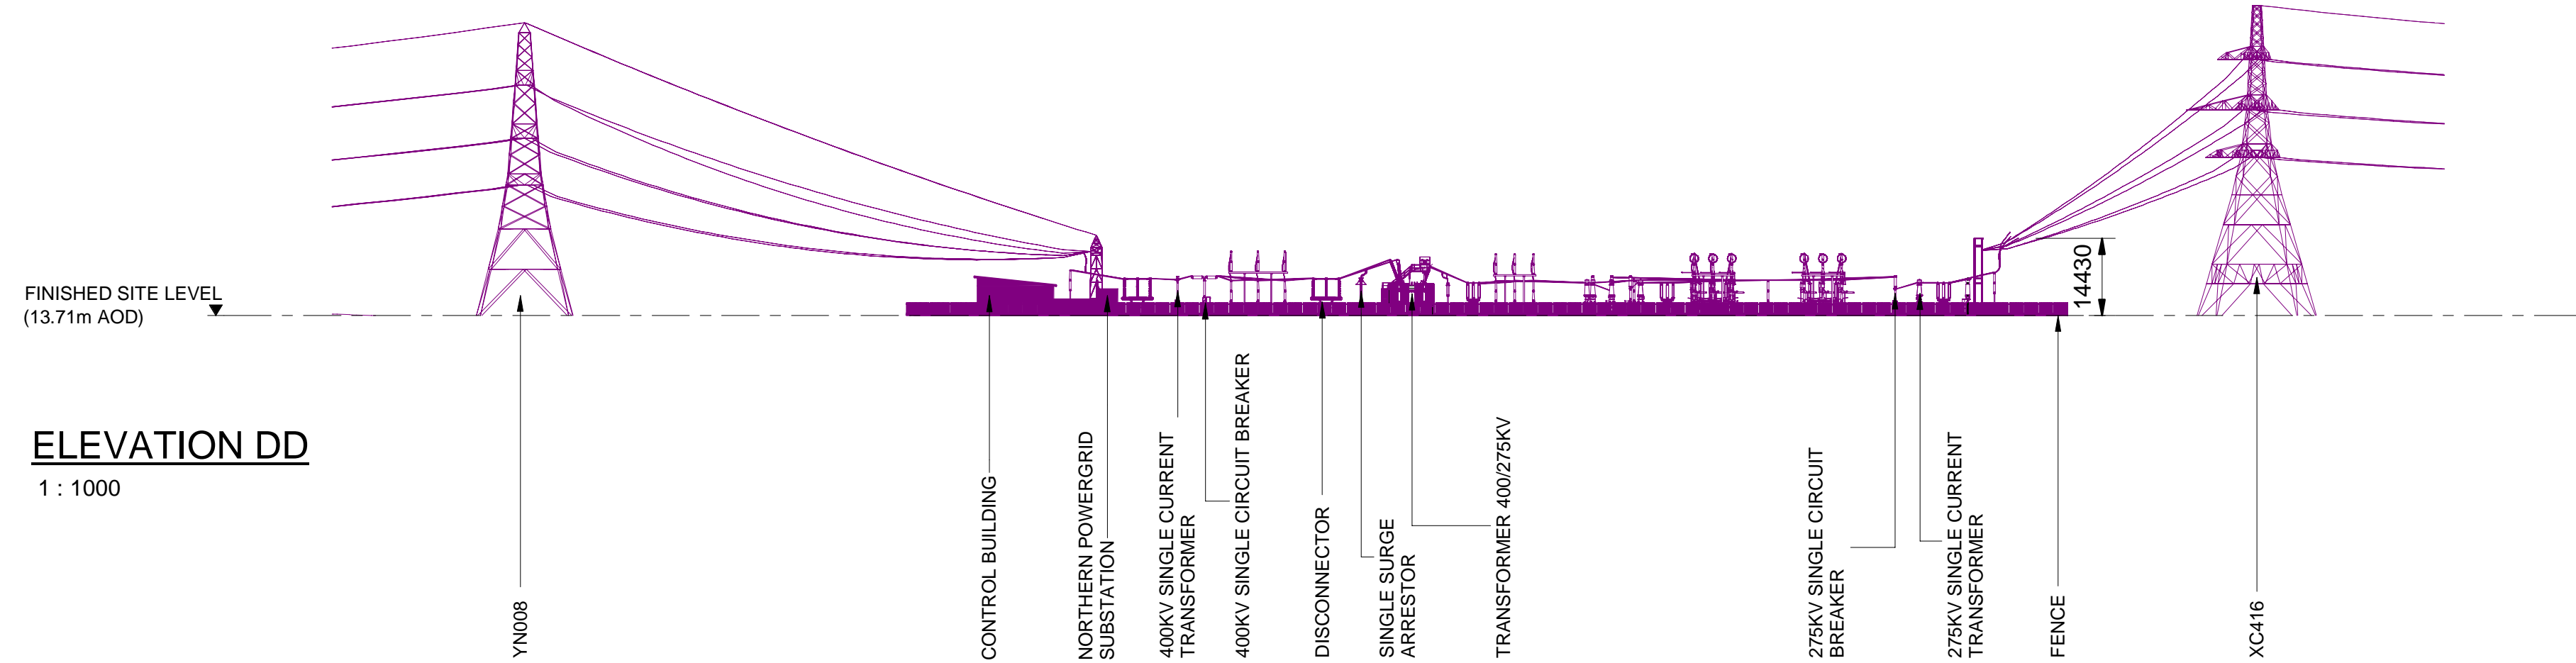

ELEVATION DD
1 : 1000

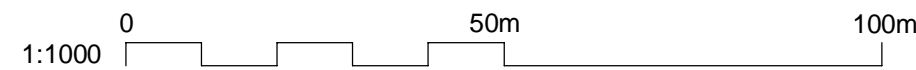


B	26/04/23	DEADLINE 2 UPDATES	NB	SF	EMD
A	01/11/22	FOR DCO SUBMISSION	NB	SF	EMD
Issue	Date	Remarks	Drawn	Checked	Approved

Title
NATIONAL GRID
(YORKSHIRE GREEN ENERGY
ENABLEMENT PROJECT) ORDER
DESIGN DRAWING: INDICATIVE SUBSTATION
ELEVATION - OVERTON
REGULATION 5(2)(o)
SHEET 3 OF 3

nationalgrid					
Application Number EN020024					
National Grid Drawing Reference DCO_DE/PS/14_03					
Scale 1:1000	Sheet Size A1	Sheet SHEET 3 OF 3	Issue B		

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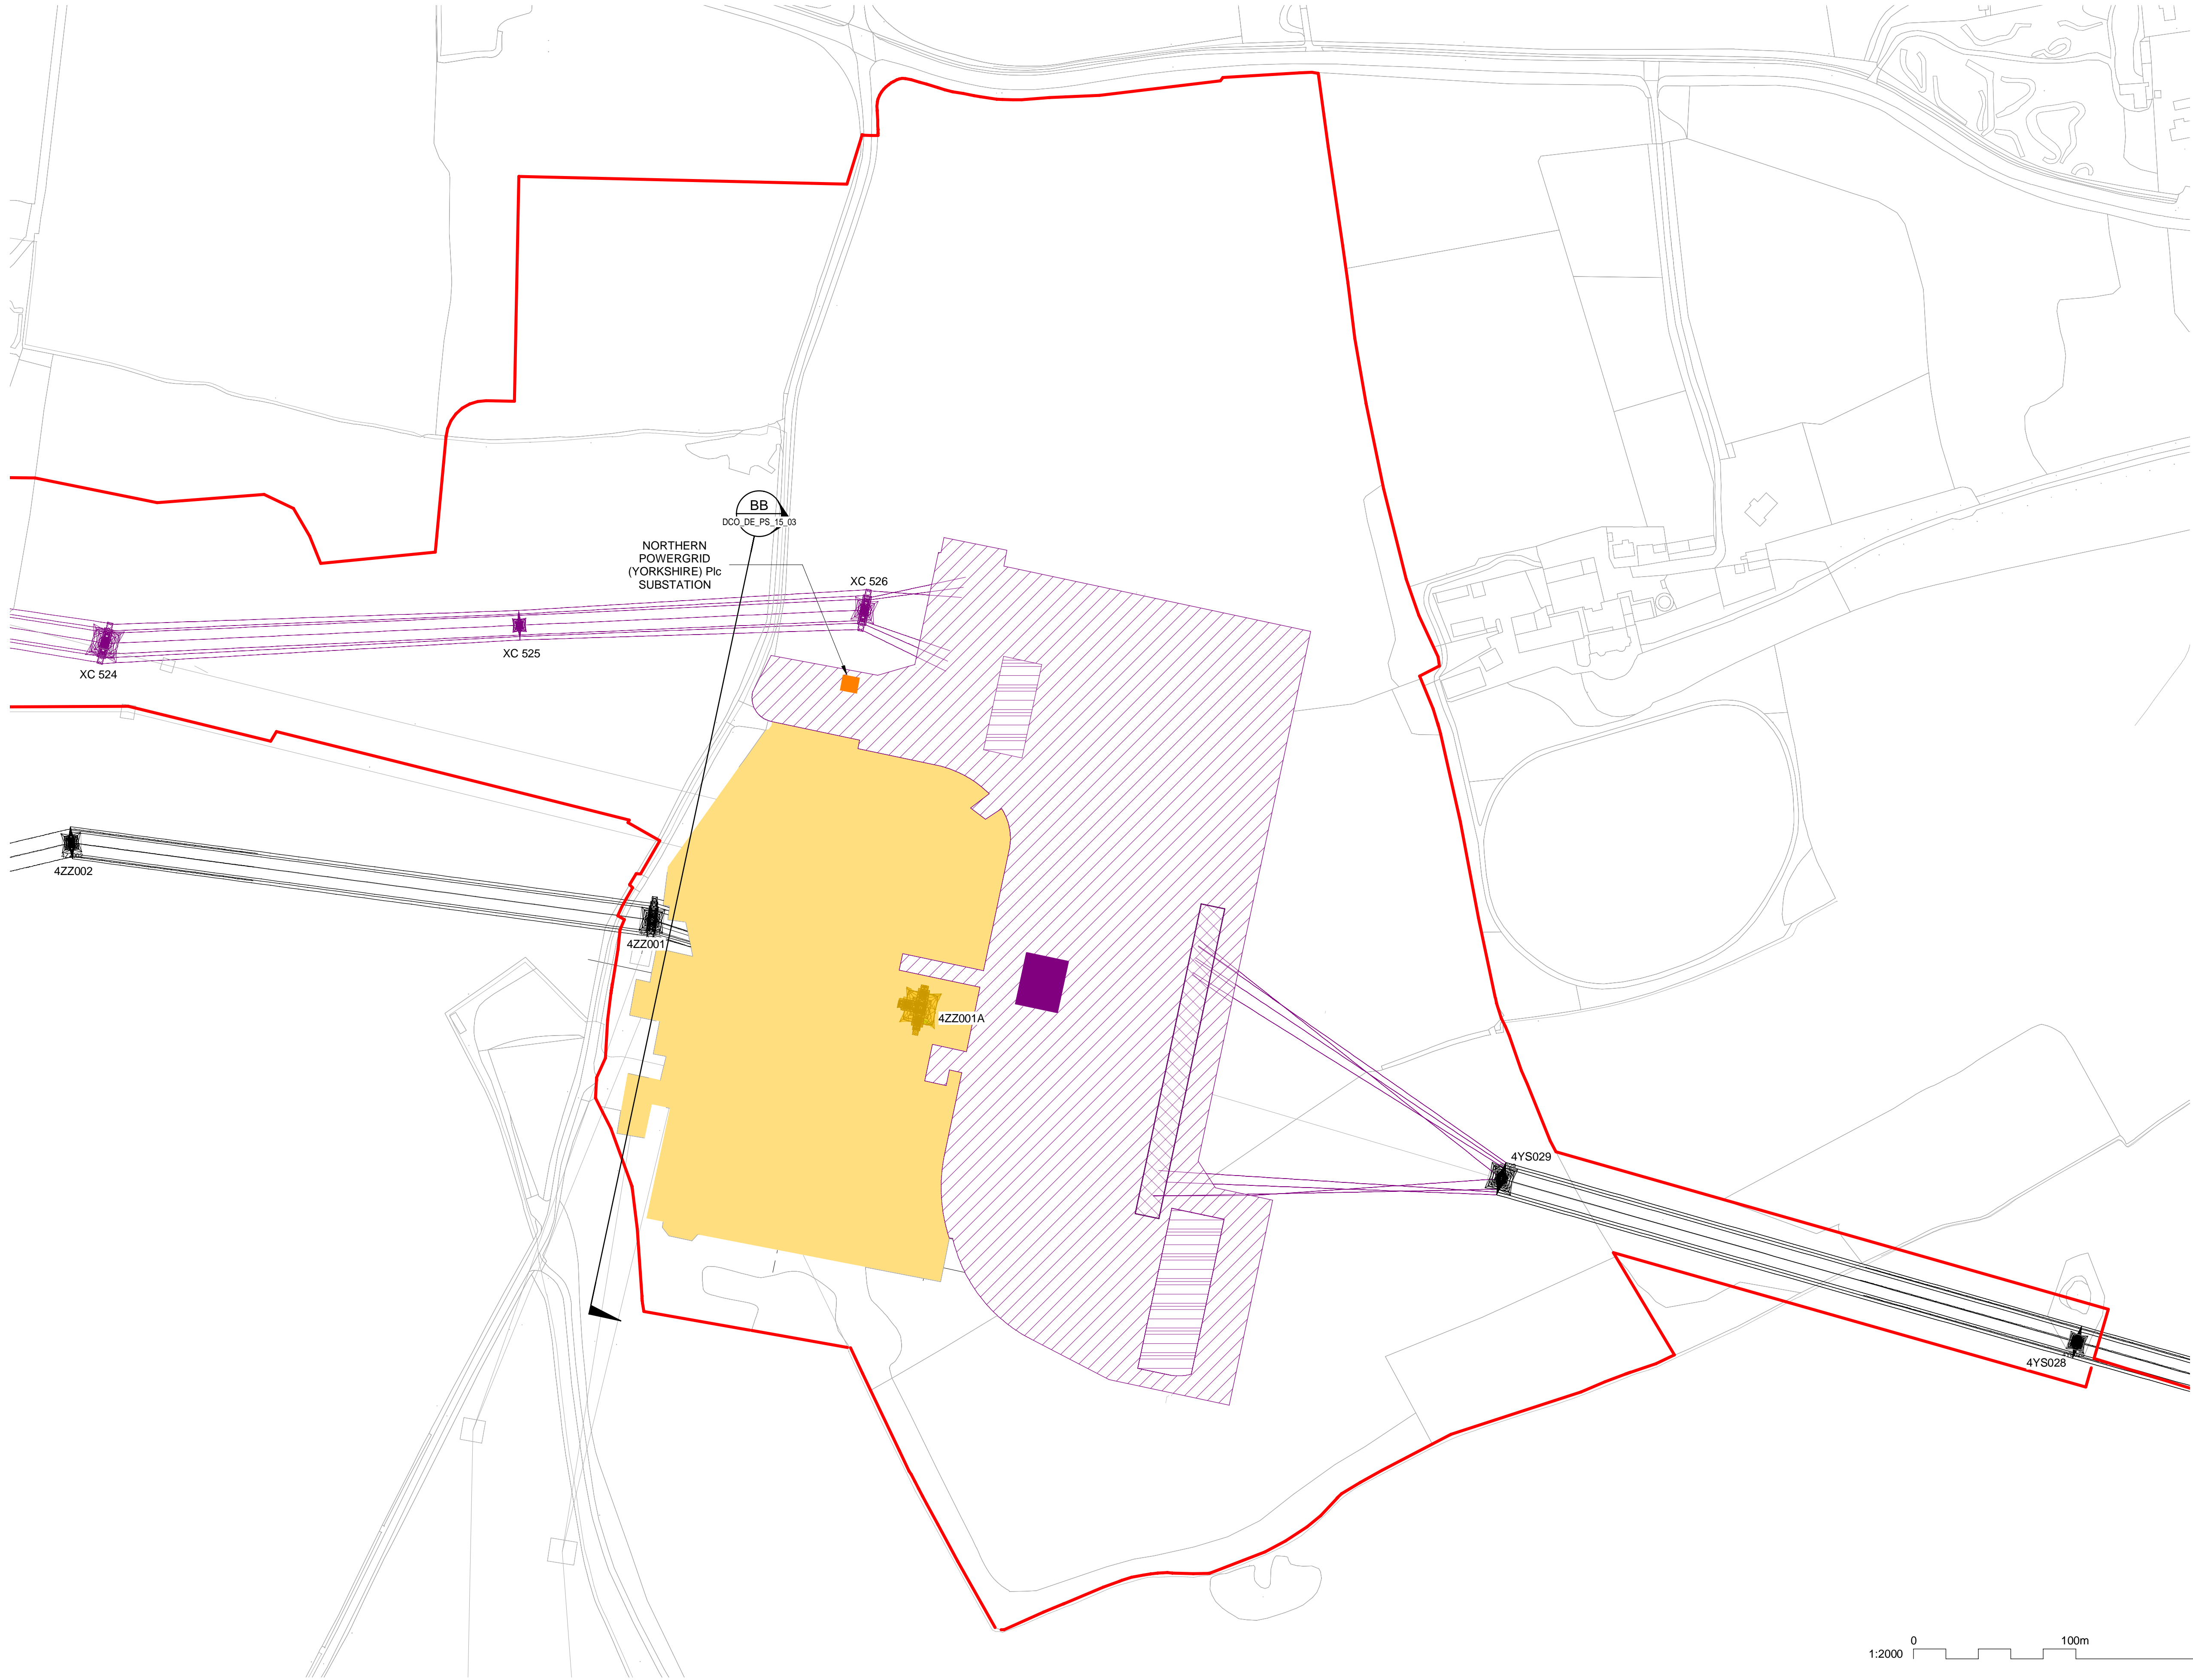
NATIONAL GRID (YORKSHIRE GREEN ENERGY ENABLEMENT PROJECT) ORDER
DESIGN DRAWING: SUBSTATION PARAMETER PLAN - MONK FRYSTON
REGULATION 5(2)(o)
SHEET 1 OF 3

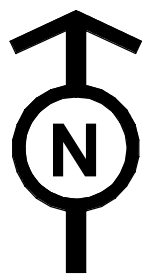Legend

- ORDER LIMITS
- NEW EQUIPMENT, NEW SUBSTATION BOUNDARY & PERIMETER FENCE
- EXISTING INFRASTRUCTURE TO BE REMOVED
- EXISTING SUBSTATION
- ZONE WITHIN WHICH FULL LINE TENSION GANTRIES AND NEW EQUIPMENT COULD BE LOCATED - (MAXIMUM HEIGHT - 15M)
- ZONE WITHIN WHICH NEW EQUIPMENT COULD BE LOCATED - (MAXIMUM HEIGHT - 15M)
- ZONE WITHIN WHICH SGT AND NEW EQUIPMENT COULD BE LOCATED - (MAXIMUM HEIGHT - 15M)
- NORTHERN POWERGRID (YORKSHIRE) Plc SUBSTATION (MAXIMUM HEIGHT - 5M)
- CONTROL BUILDING
- ELEVATION SYMBOL

Notes

- THIS DRAWING IS SCALED AT PAPER SIZE A1. THEREFORE ANY PRINTS TAKEN AT SMALLER SIZES WILL AFFECT ACCURACY OF THE MEASUREMENT UNITS AND SHOULD NOT BE SCALED AGAINST.
- FOR ADDITIONAL DETAIL ON THE PLAN SUITES, PLEASE REFER TO DOCUMENT 2.3 PLAN GUIDANCE DOCUMENT, LOCATED IN VOLUME 2 OF THE DCO APPLICATION.
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- ALL SPATIAL COORDINATES RELATE TO THE ORDNANCE SURVEY, BRITISH NATIONAL GRID (OSGB36).




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Sheet Y Centroid Coordinate: 457427
BACKGROUND MAPPING INFORMATION HAS BEEN REPRODUCED FROM THE ORDNANCE SURVEY BY PERMISSION OF ORDNANCE SURVEY OF THE CONTROLLER OF HER MAJESTY'S STATIONERY OFFICE. © CROWN OFFICE COPYRIGHT ORDNANCE SURVEY. BLUESKY INTERNATIONAL LTD © NATIONAL GRID ELECTRICITY -100024241.

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Issue	Date	Remarks	Drawn	Checked	Approved


NATIONAL GRID
(YORKSHIRE GREEN ENERGY
ENABLEMENT PROJECT) ORDER
DESIGN DRAWING: SUBSTATION PARAMETER
PLAN - MONK FRYSTON
REGULATION 5(2)(o)
SHEET 1 OF 3

nationalgrid

<u>Application Number</u>		EN020024	
<u>National Grid Drawing Reference</u>			
DCO_DE/PS/15_01			
Scale	Sheet Size	Sheet	Issue
1:2000	A1	SHEET 1 OF 3	B

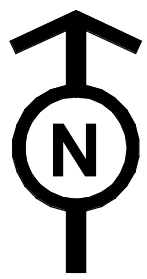

NATIONAL GRID (YORKSHIRE GREEN ENERGY ENABLEMENT PROJECT) ORDER
DESIGN DRAWING: INDICATIVE SUBSTATION LAYOUT - MONK FRYSTON
REGULATION 5(2)(o)
SHEET 2 OF 3

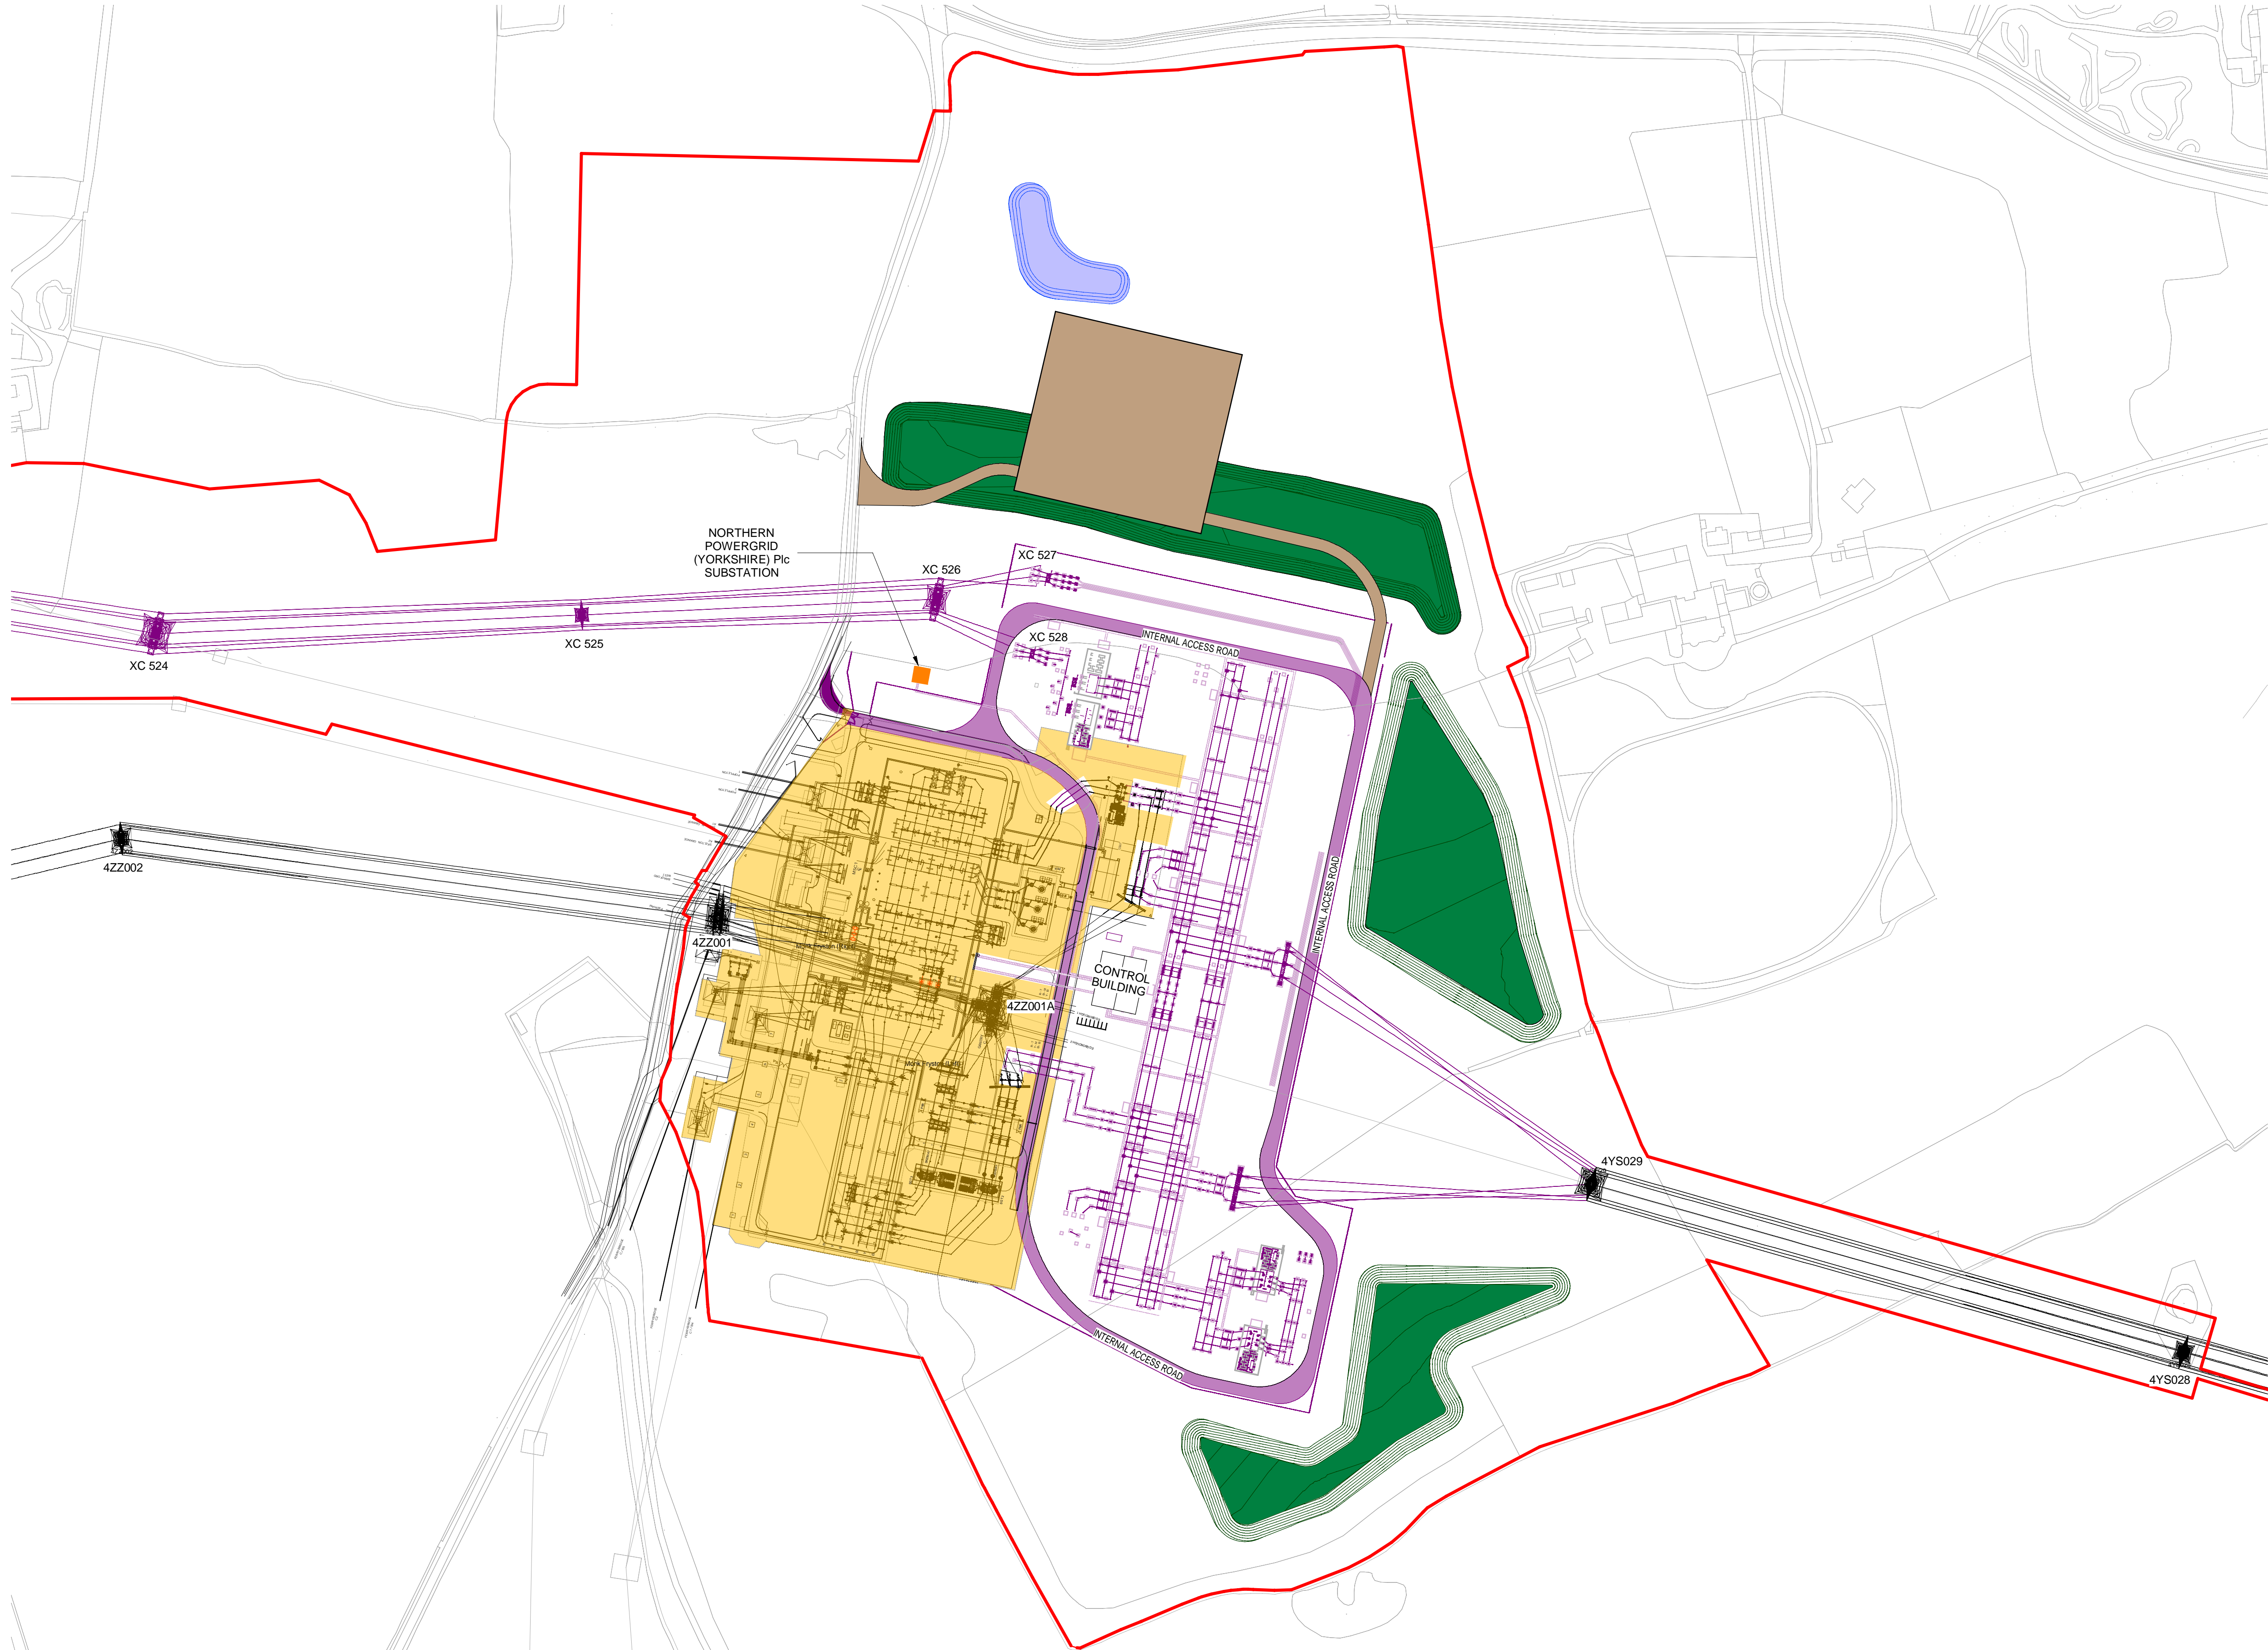

Legend

- ORDER LIMIT
- NEW EQUIPMENT
- EXISTING EQUIPMENTS & SUBSTATION
- PERMANENT BUNDS
- EXISTING SUBSTATION
- PERMANENT ACCESS ROAD
- CONSTRUCTION COMPOUND, TEMPORARY ACCESS ROAD
- TEMPORARY DRAINAGE
- PERMANENT LANDSCAPE BUND
- NORTHERN POWERGRID (YORKSHIRE) Plc SUBSTATION
- 275kV SINGLE CIRCUIT BREAKER
- 400kV SINGLE CIRCUIT BREAKER
- SINGLE CABLE SEALING END
- 275kV SINGLE CURRENT TRANSFORMER
- 400kV SINGLE CURRENT TRANSFORMER
- SINGLE POST INSULATOR
- SINGLE PANTOGRAPH DISCONNECTOR
- DISCONNECTOR WITH EARTH SWITCH
- FULL LINE TENSION GANTRY
- EARTH SWITCH
- ELEVATION SYMBOL

Notes

- THIS DRAWING IS SCALED AT PAPER SIZE A1. THEREFORE ANY PRINTS TAKEN AT SMALLER SIZES WILL AFFECT ACCURACY OF THE MEASUREMENT UNITS AND SHOULD NOT BE SCALED AGAINST.
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Coordinate System: British National Grid

Sheet X Centroid Coordinate: 455675
Sheet Y Centroid Coordinate: 457427

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A	01/11/22	FOR DCO SUBMISSION	NB	SF	EMD
Issue	Date	Remarks	Drawn	Checked	Approved

Title


NATIONAL GRID
(YORKSHIRE GREEN ENERGY
ENABLEMENT PROJECT) ORDER
DESIGN DRAWINGS: INDICATIVE SUBSTATION
LAYOUT - MONK FRYSTON
REGULATION 5(2)(o)
SHEET 2 OF 3

nationalgrid

Application Number
EN020024


National Grid Drawing Reference
DCO_DE/PS/15_02

Scale	Sheet Size	Sheet	Issue
1:2000	A1	SHEET 2 OF 3	B

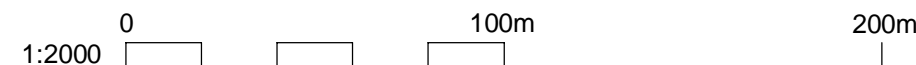

NATIONAL GRID (YORKSHIRE GREEN ENERGY ENABLEMENT PROJECT) ORDER
DESIGN DRAWING: INDICATIVE SUBSTATION ELEVATION - MONK FRYSTON
REGULATION 5(2)(o)
SHEET 3 OF 3

Legend

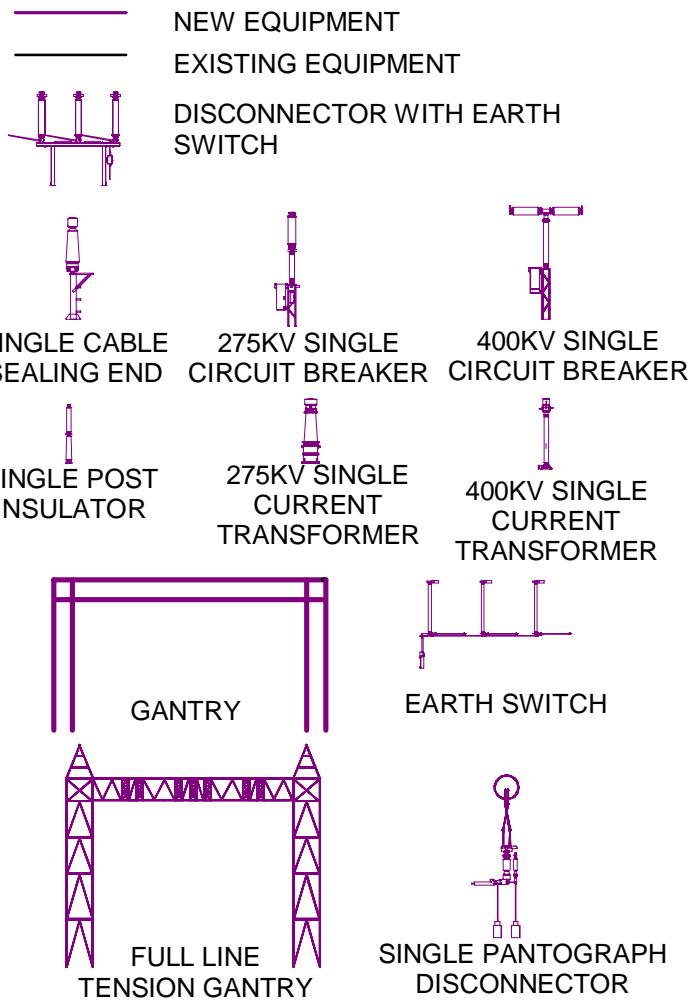


Notes

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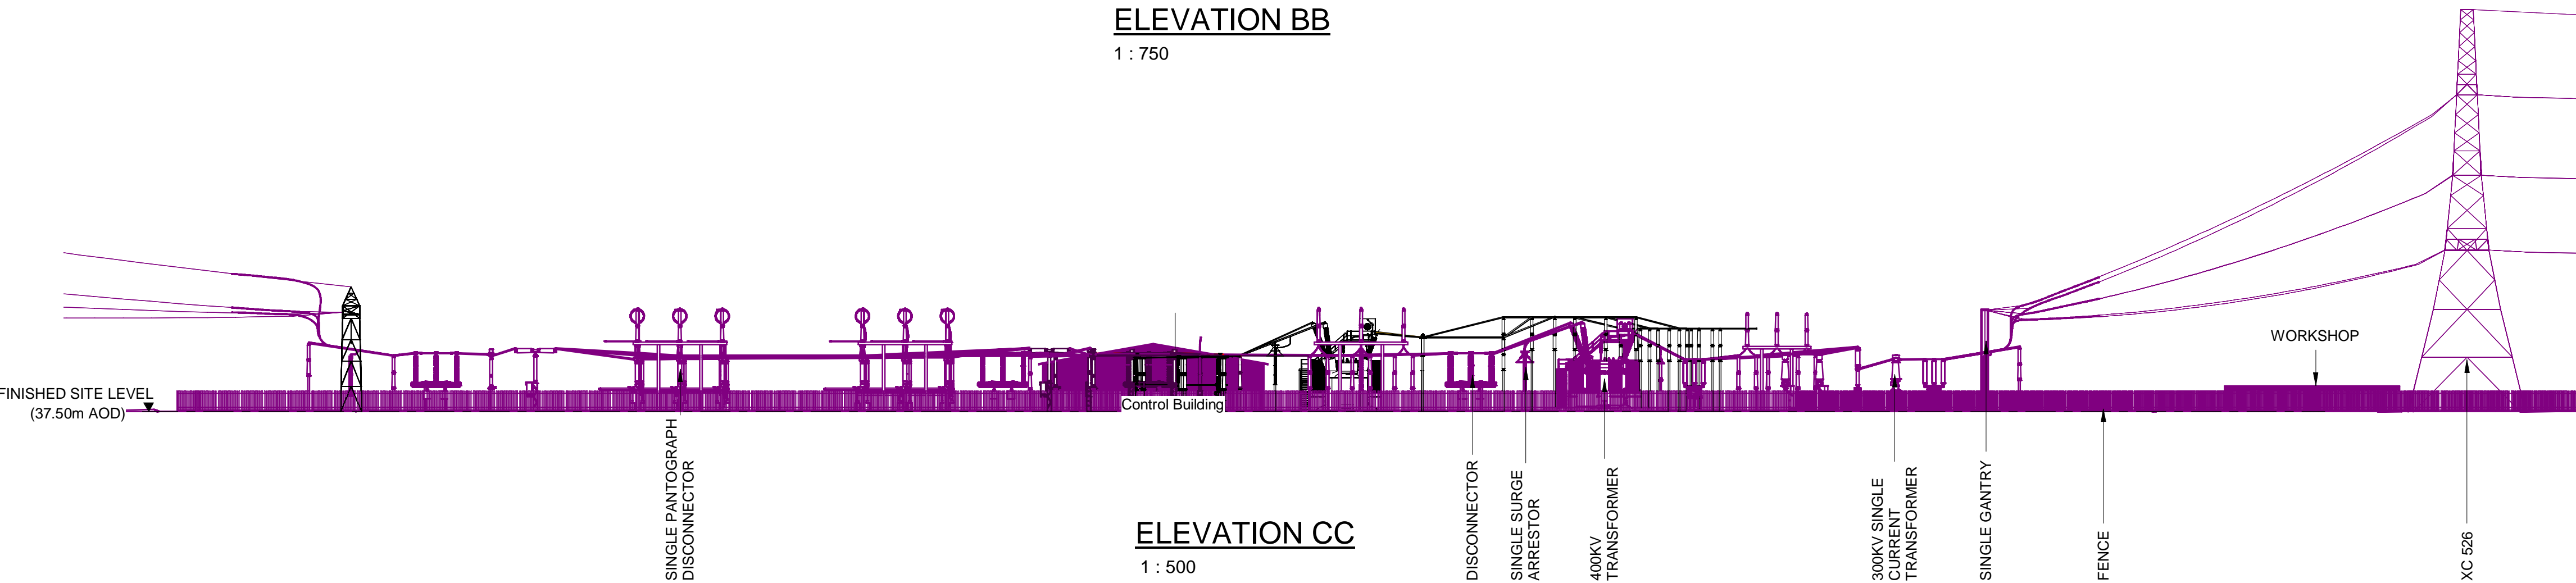
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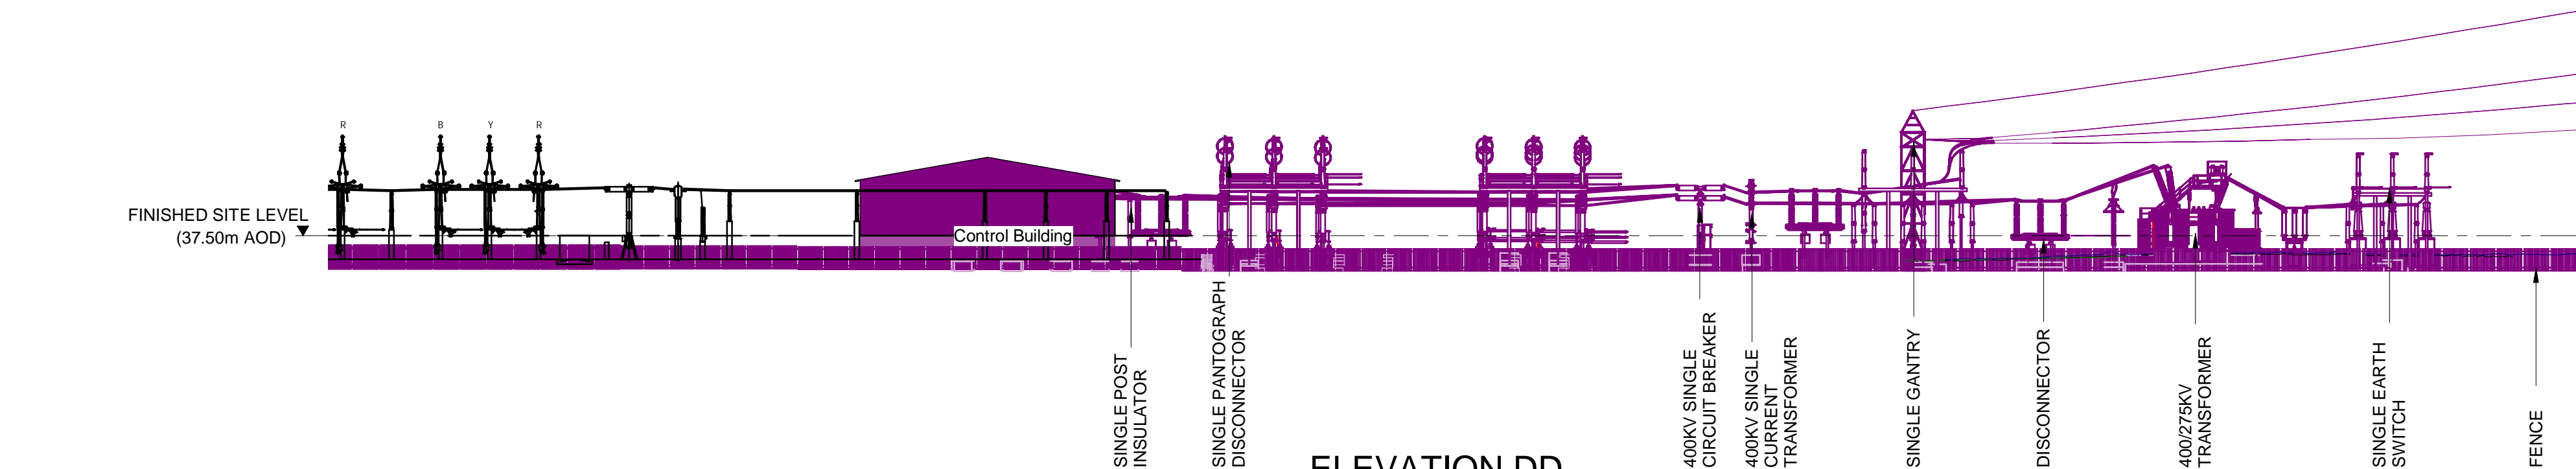
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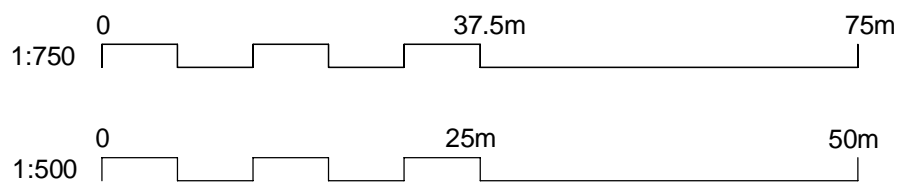
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1 : 500



ELEVATION DD

1 : 500

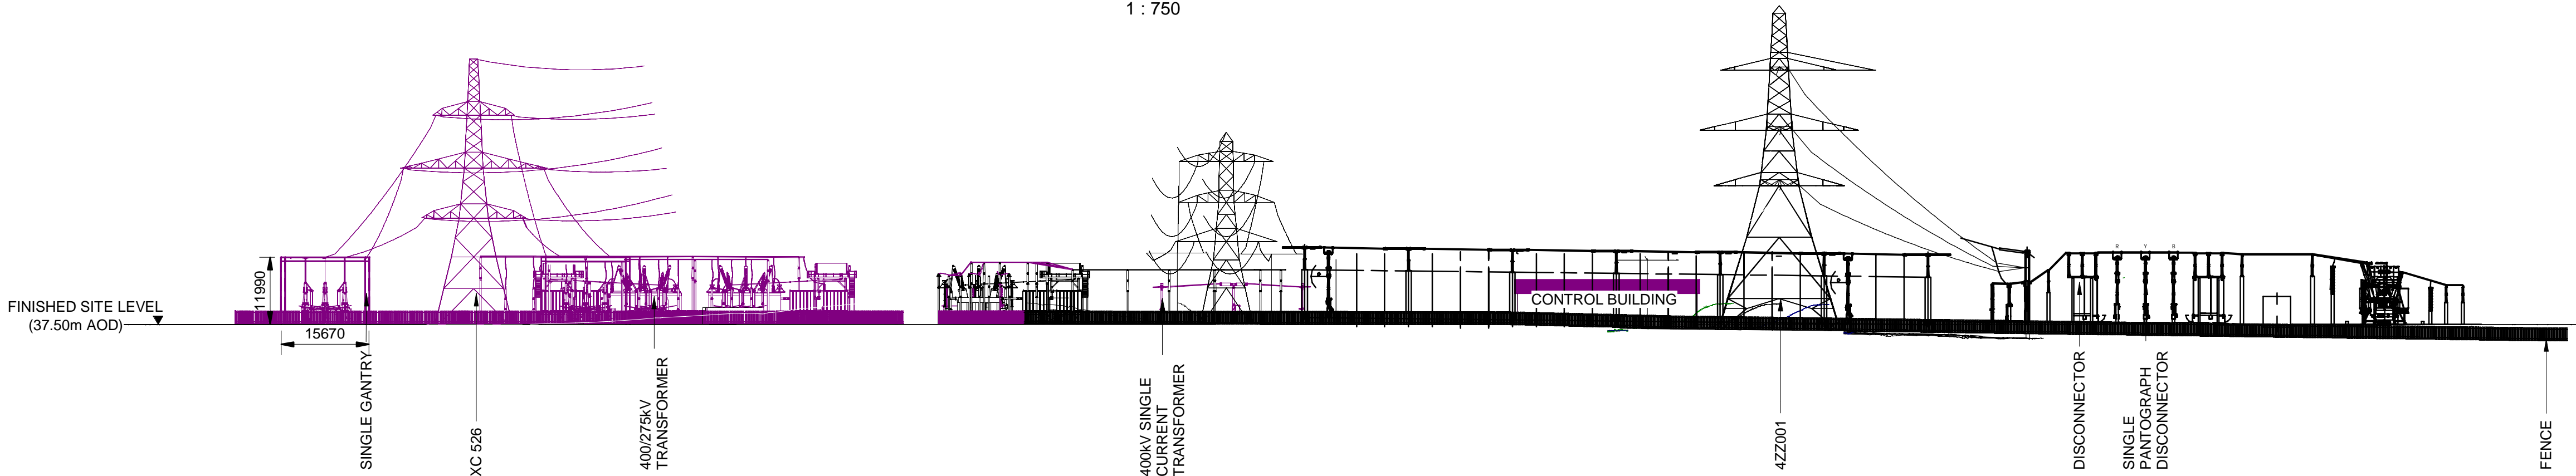


B	26/04/23	DEADLINE 2 UPDATES	NB	SF	EMD
A	01/11/22	FOR DCO SUBMISSION	NB	SF	EMD
Issue	Date	Remarks	Drawn	Checked	Approved

Title
NATIONAL GRID
(YORKSHIRE GREEN ENERGY
ENABLEMENT PROJECT) ORDER
DESIGN DRAWING: INDICATIVE SUBSTATION
ELEVATION - MONK FRYSTON
REGULATION 5(2)(o)
SHEET 3 OF 3

nationalgrid			
<u>Application Number</u>		EN020024	
<u>National Grid Drawing Reference</u>			
DCO_DE/PS/15_03			
Scale	Sheet Size	Sheet	Issue
1:750 / 1:500	A1	SHEET 3 OF 3	B

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NATIONAL GRID (YORKSHIRE GREEN ENERGY ENABLEMENT PROJECT) ORDER
DESIGN DRAWING: SUBSTATION PARAMETER PLAN - OSBALDWICK
REGULATION 5(2)(o)
SHEET 1 OF 3

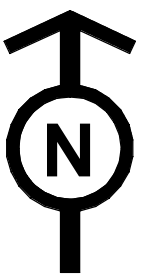Legend

- ORDER LIMITS
- EXISTING EQUIPMENT
- NEW EQUIPMENT & NEW SUBSTATION BOUNDARY
- ZONE WITHIN WHICH NEW EQUIPMENT COULD BE LOCATED (MAXIMUM HEIGHT - 15M)
- EXISTING SUBSTATION
- ELEVATION SYMBOL

Notes



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- ALL SPATIAL COORDINATES RELATE TO THE ORDNANCE SURVEY, BRITISH NATIONAL GRID (OSGB36).


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Sheet Y Centroid Coordinate: 451656
BACKGROUND MAPPING INFORMATION HAS BEEN REPRODUCED FROM THE ORDNANCE SURVEY BY PERMISSION OF ORDNANCE SURVEY OF THE CONTROLLER OF HER MAJESTY'S STATIONERY OFFICE. © CROWN OFFICE COPYRIGHT ORDNANCE SURVEY. BLUESKY INTERNATIONAL LTD © NATIONAL GRID ELECTRICITY-100024241.

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Issue	Date	Remarks	Drawn	Checked	Approved

Title
NATIONAL GRID
(YORKSHIRE GREEN ENERGY
ENABLEMENT PROJECT) ORDER
DESIGN DRAWING: SUBSTATION PARAMETER PLAN -
OSBALDWICK
REGULATION 5(2)(o)
SHEET 1 OF 3

nationalgrid					
Application Number					
EN020024					
National Grid Drawing Reference					
DCO_DE/PS/16_01					
Scale	Sheet Size	Sheet	Issue		
1:1000	A1	SHEET 1 OF 3	B		

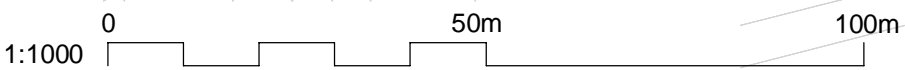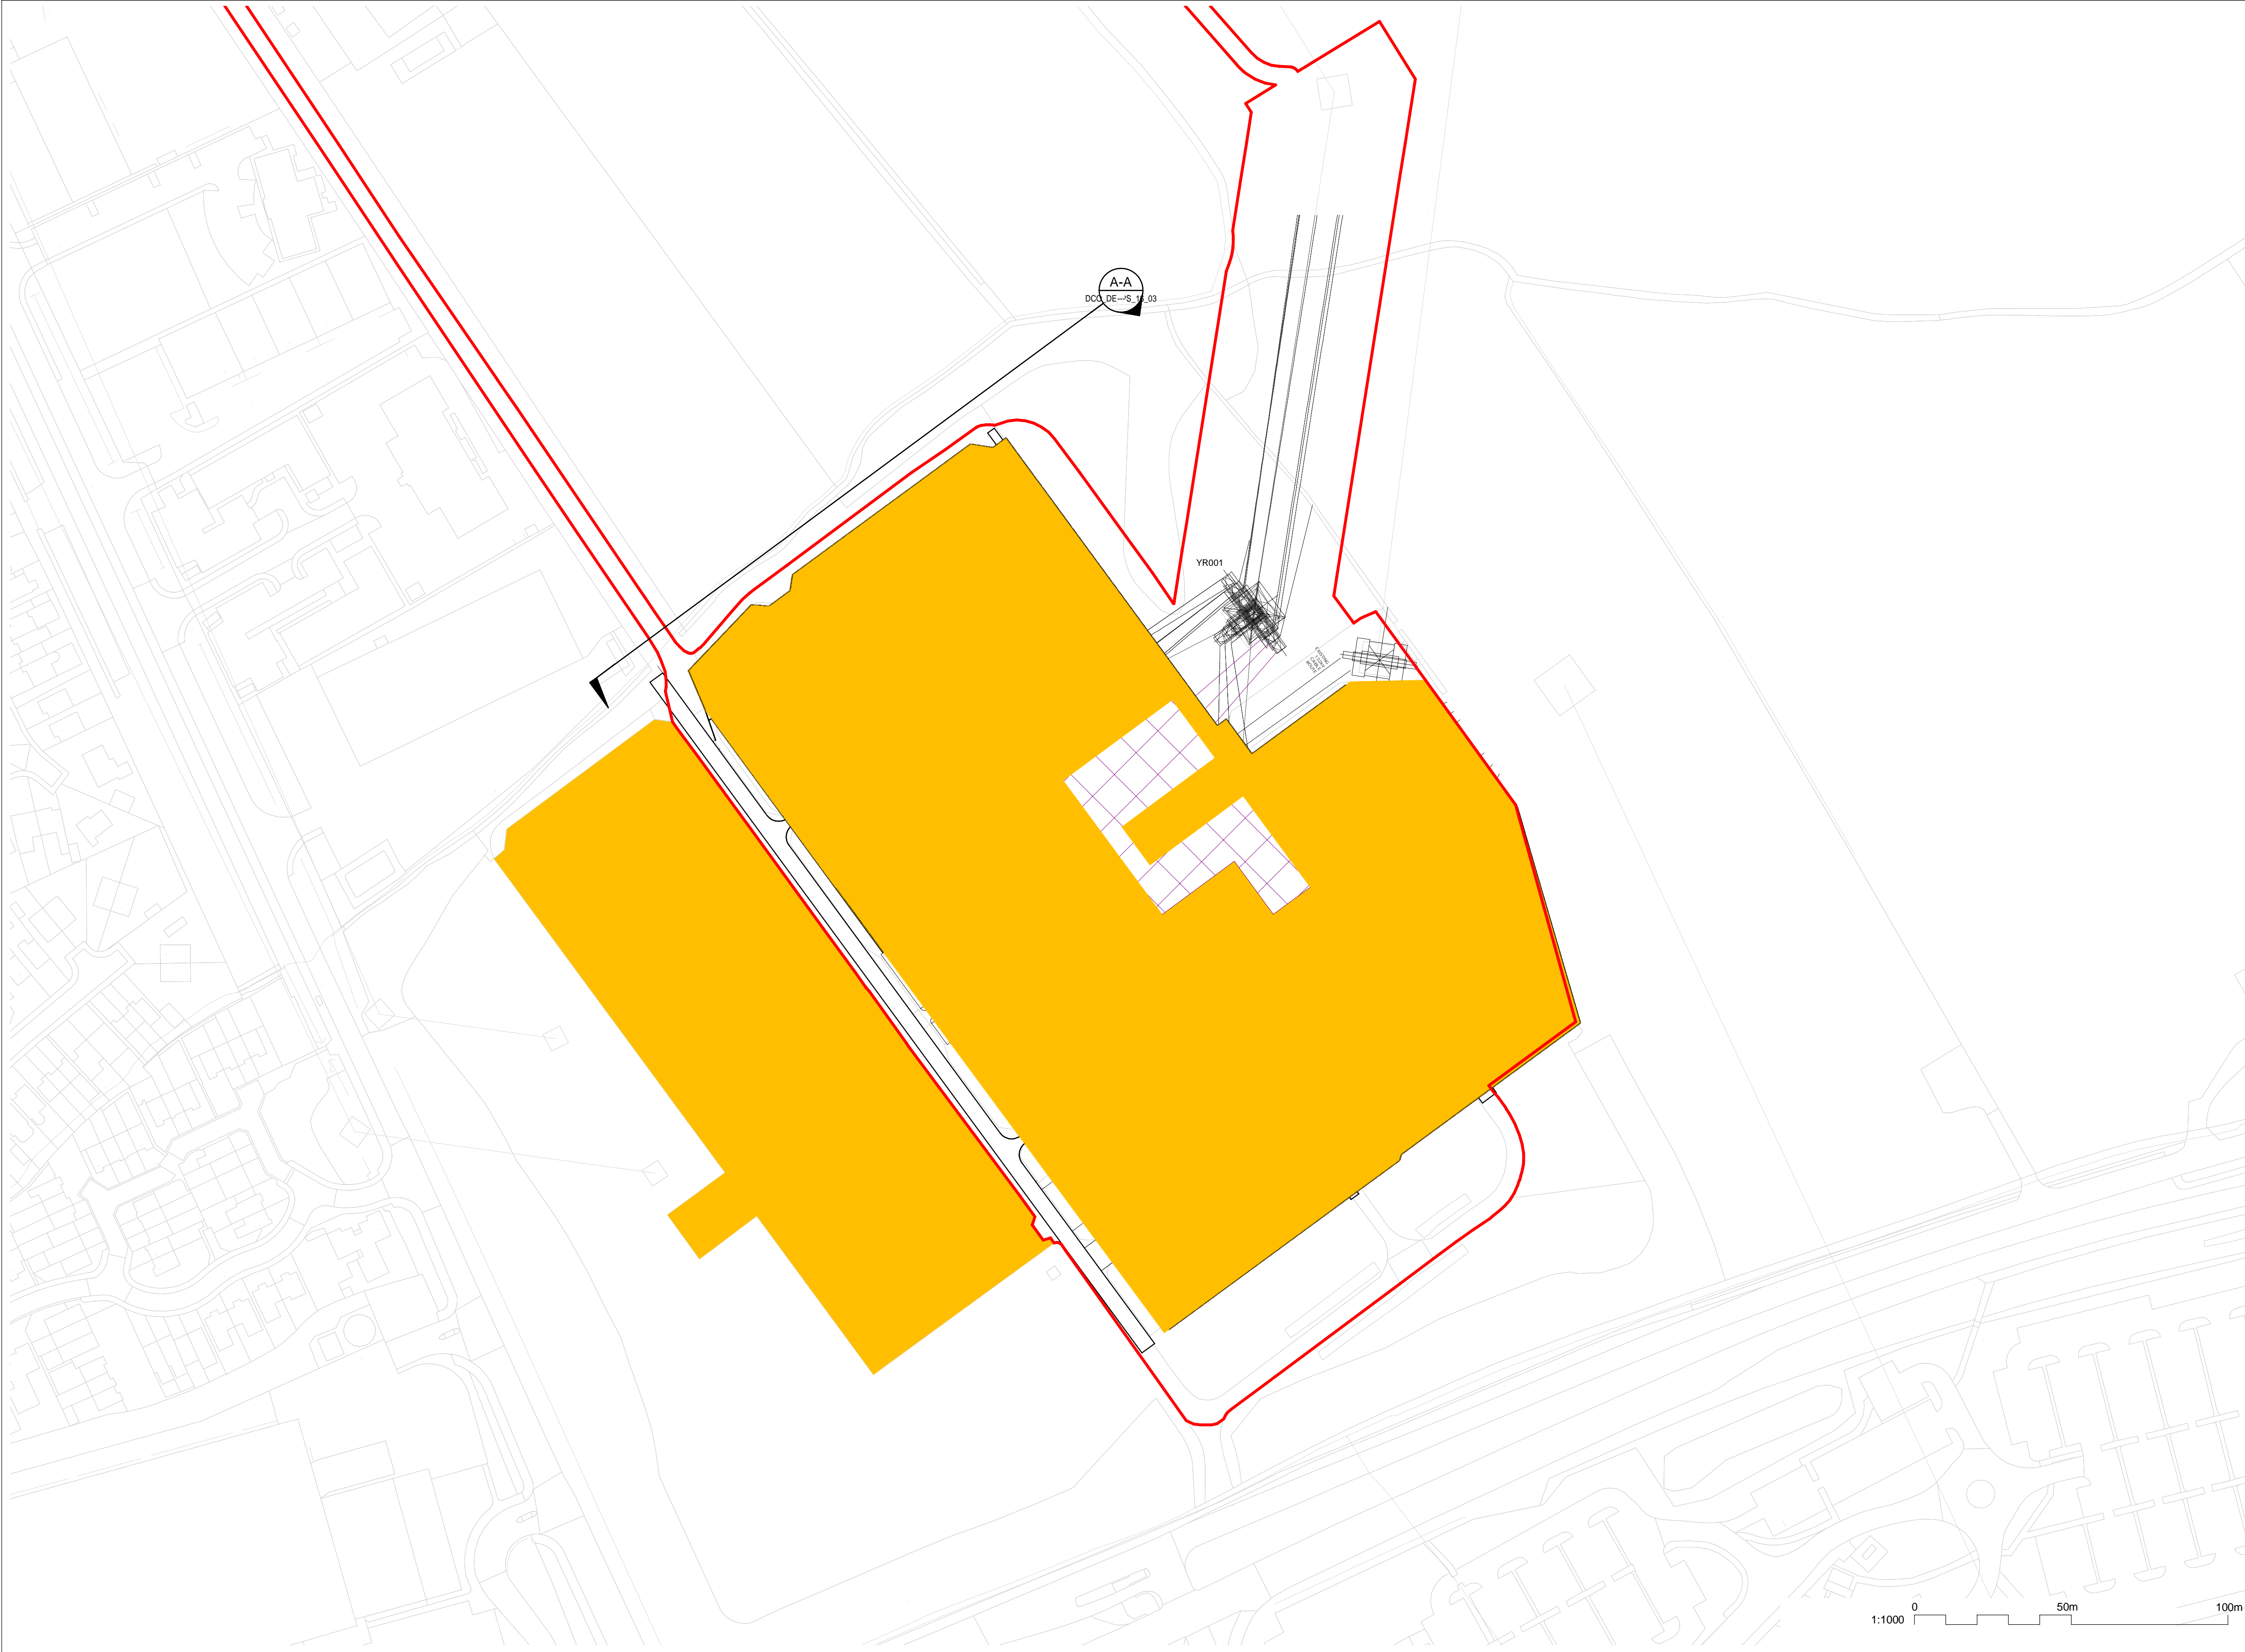

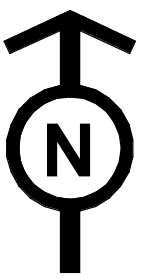

THE NATIONAL GRID (YORKSHIRE GREEN ENERGY ENABLEMENT PROJECT) ORDER
DESIGN DRAWING: INDICATIVE SUBSTATION LAYOUT - OSBALDWICK
REGULATION 5(2)(o)
SHEET 2 OF 3

Legend

- ORDER LIMITS
- EXISTING EQUIPMENT
- NEW EQUIPMENT
- EXISTING SUBSTATION
- SINGLE CABLE SEALING END
- SINGLE CURRENT TRANSFORMER
- SINGLE POST INSULATOR
- SINGLE CAPACITIVE VOLTAGE TRANSFORMER
- SINGLE CIRCUIT BREAKER
- EARTH SWITCH
- ELEVATION SYMBOL

Notes

- THIS DRAWING IS SCALED AT PAPER SIZE A1, THEREFORE ANY PRINTS TAKEN AT SMALLER SIZES WILL AFFECT ACCURACY OF THE MEASUREMNT UNITS AND SHOULD NOT BE SCALED AGAINST.
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- ALL SPATIAL COORDINATES RELATE TO THE ORDNDANCE SURVEY, BRITISH NATIONAL GRID (OSGB36).

Coordinate System: British National Grid
Sheet X Centroid Coordinate: 464235
Sheet Y Centroid Coordinate: 451656

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Issue	Date	Remarks	Drawn	Checked	Approved



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(YORKSHIRE GREEN ENERGY
ENABLEMENT PROJECT) ORDER
DESIGN DRAWING: INDICATIVE SUBSTATION LAYOUT -
OSBALDWICK
REGULATION 5(2)(o)
SHEET 2 OF 3

nationalgrid

Application Number
EN020024


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DCO_DE/PS/16_02

Scale	Sheet Size	Sheet	Issue
1:1000	A1	SHEET 2 OF 3	B

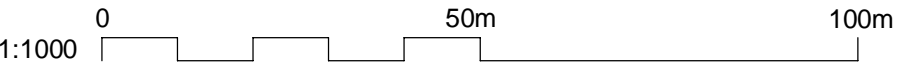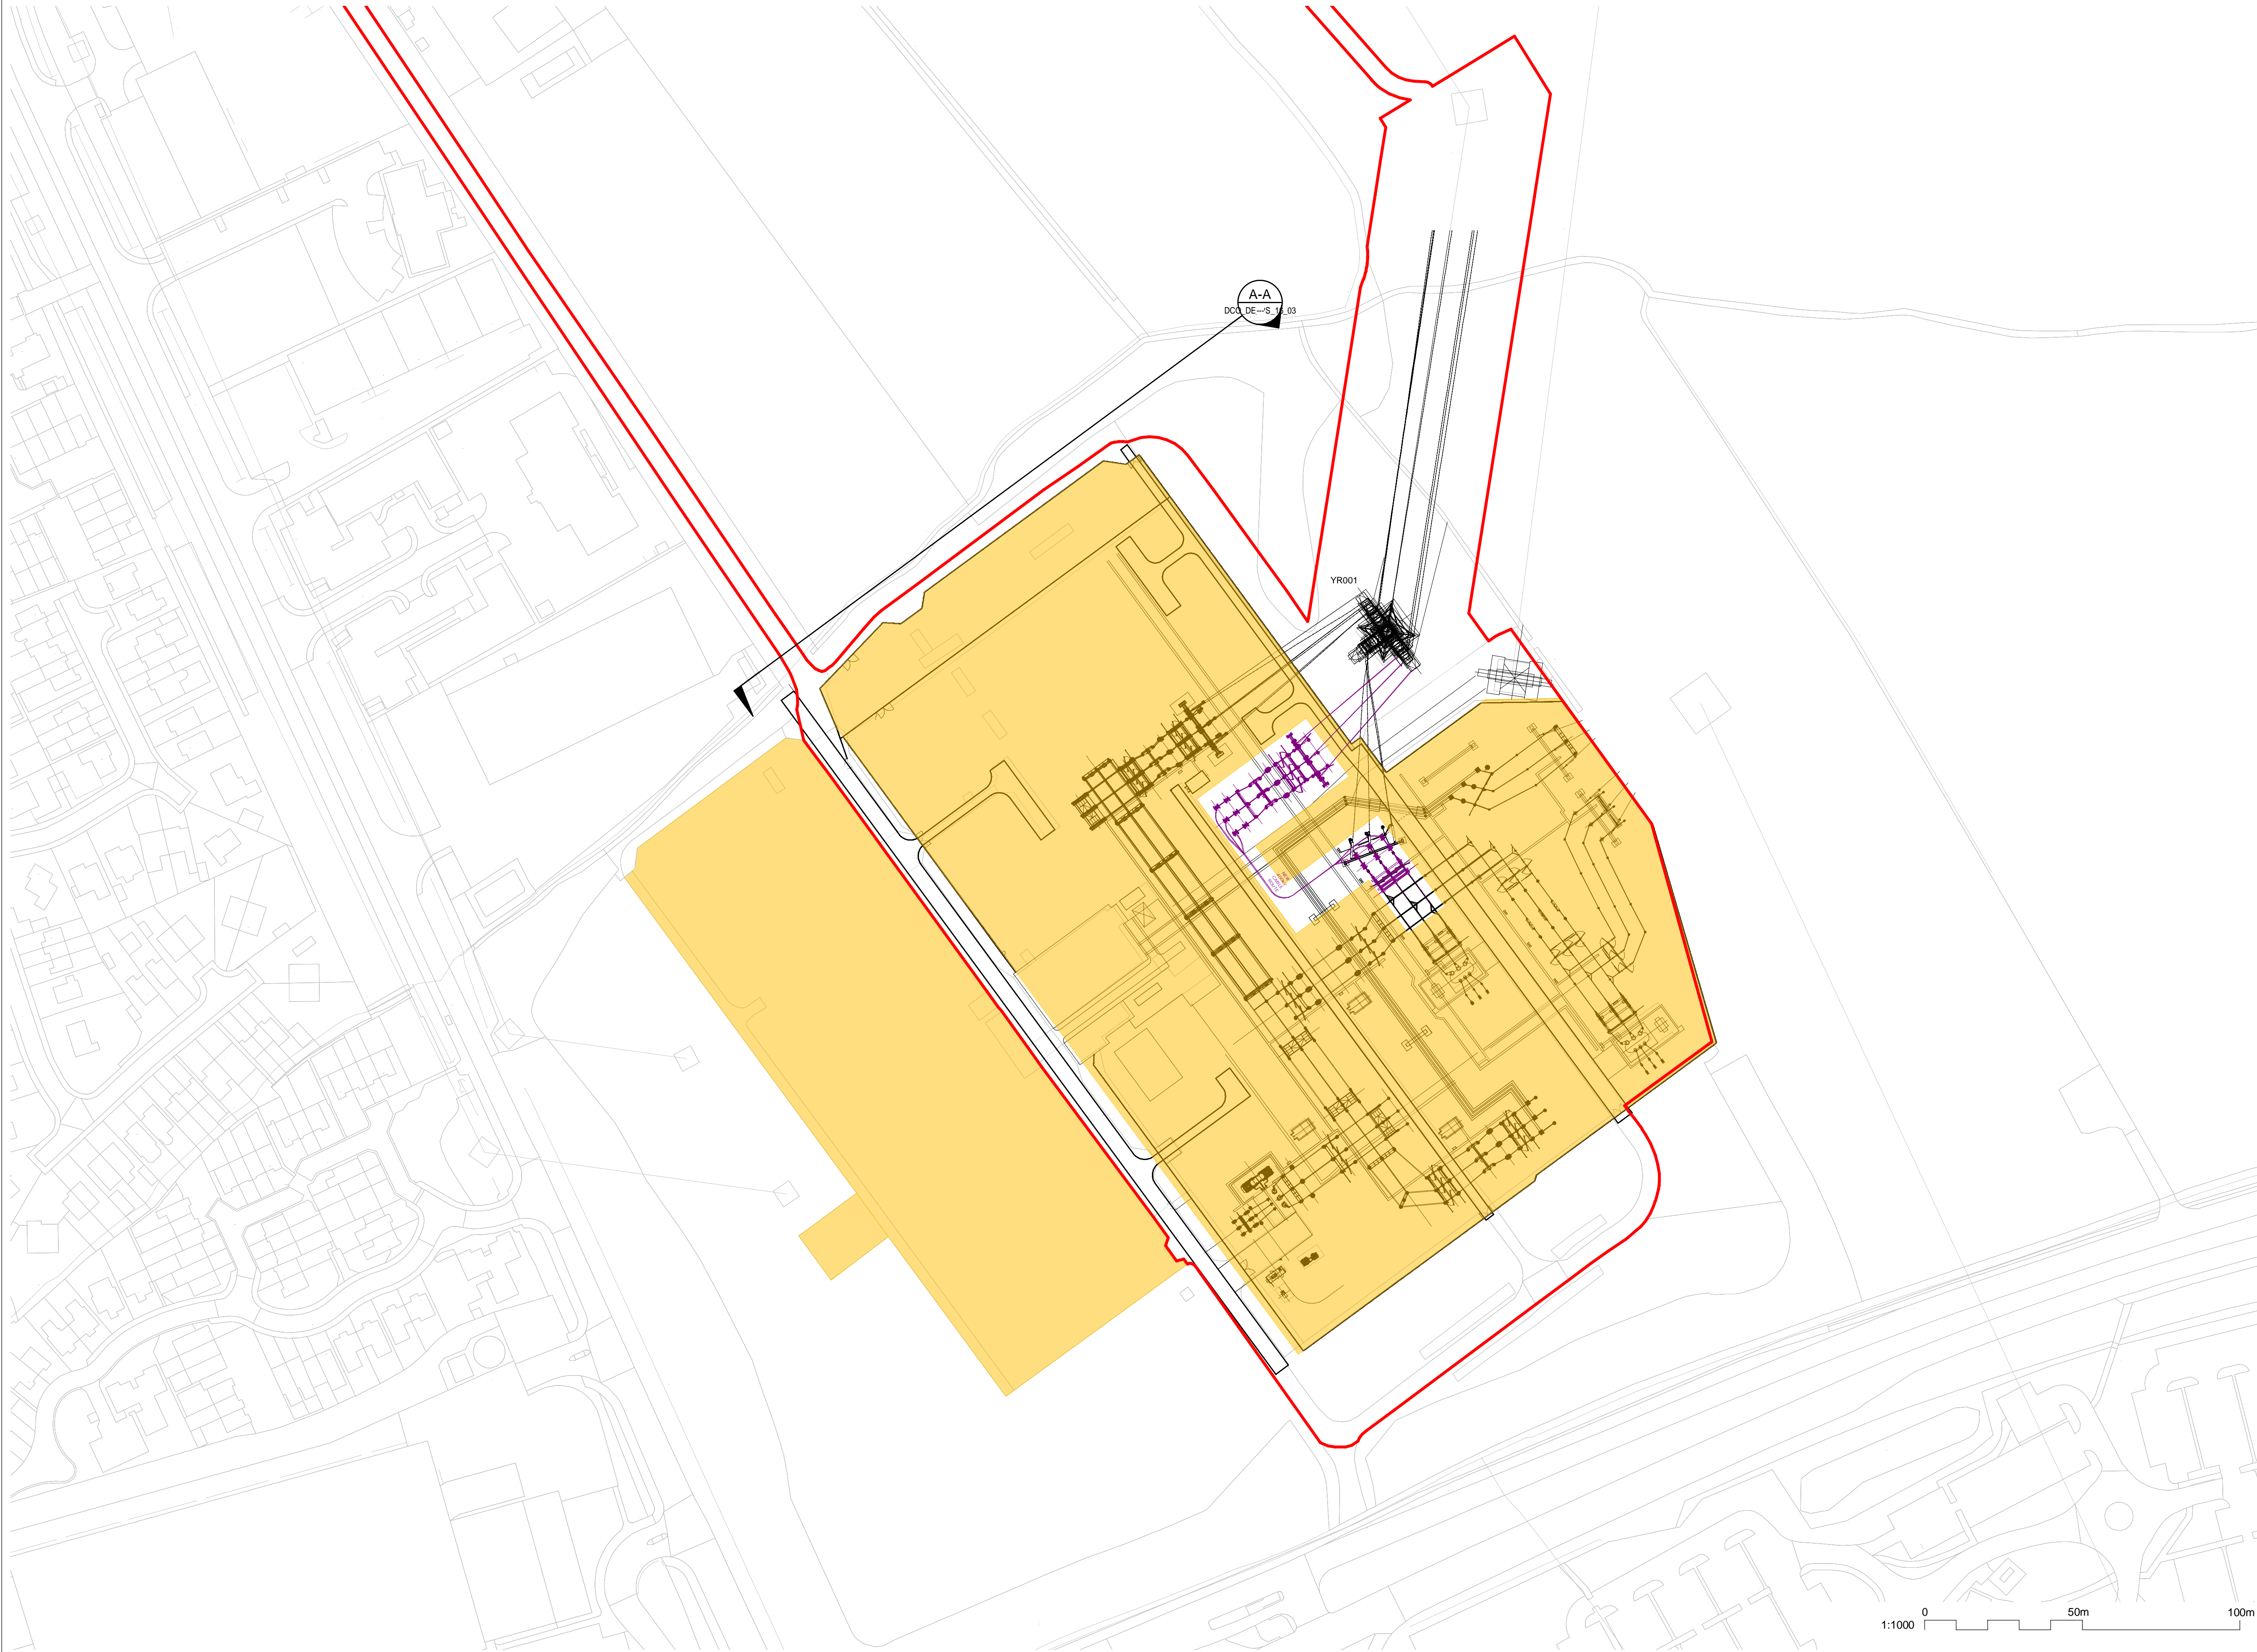


NATIONAL GRID (YORKSHIRE GREEN ENERGY ENABLEMENT PROJECT) ORDER
DESIGN DRAWING: INDICATIVE SUBSTATION ELEVATION - OSBALDWICK
REGULATION 5(2)(o)
SHEET 3 OF 3

Legend

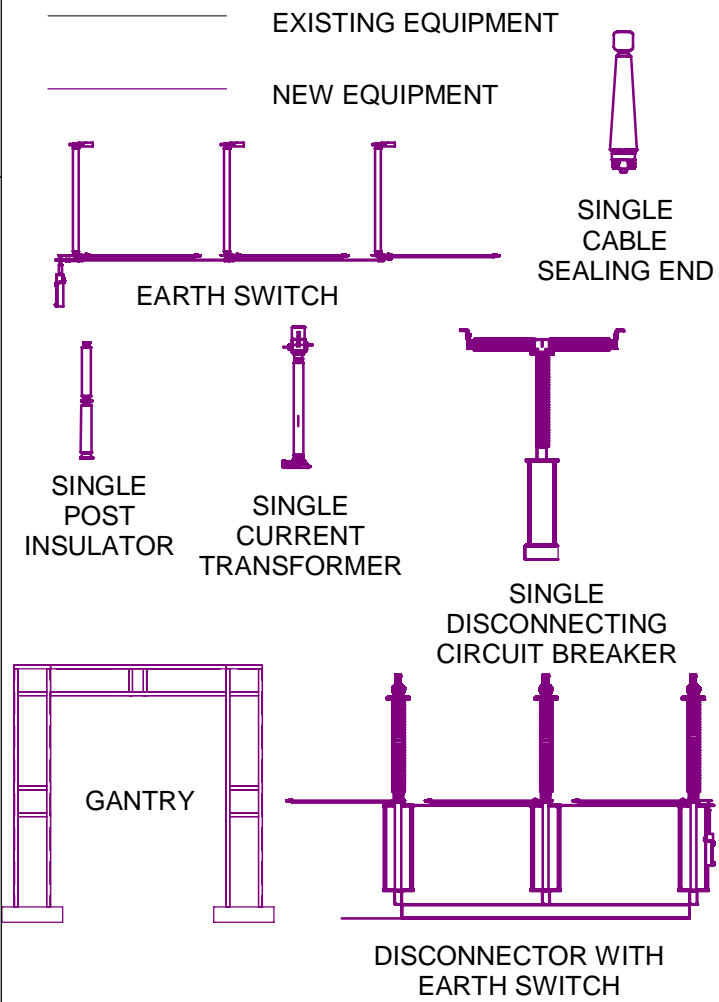

Notes

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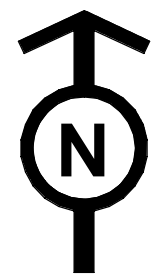
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A	01/11/22	FOR DCO SUBMISSION	NB	SF	EMD
Issue	Date	Remarks	Drawn	Checked	Approved
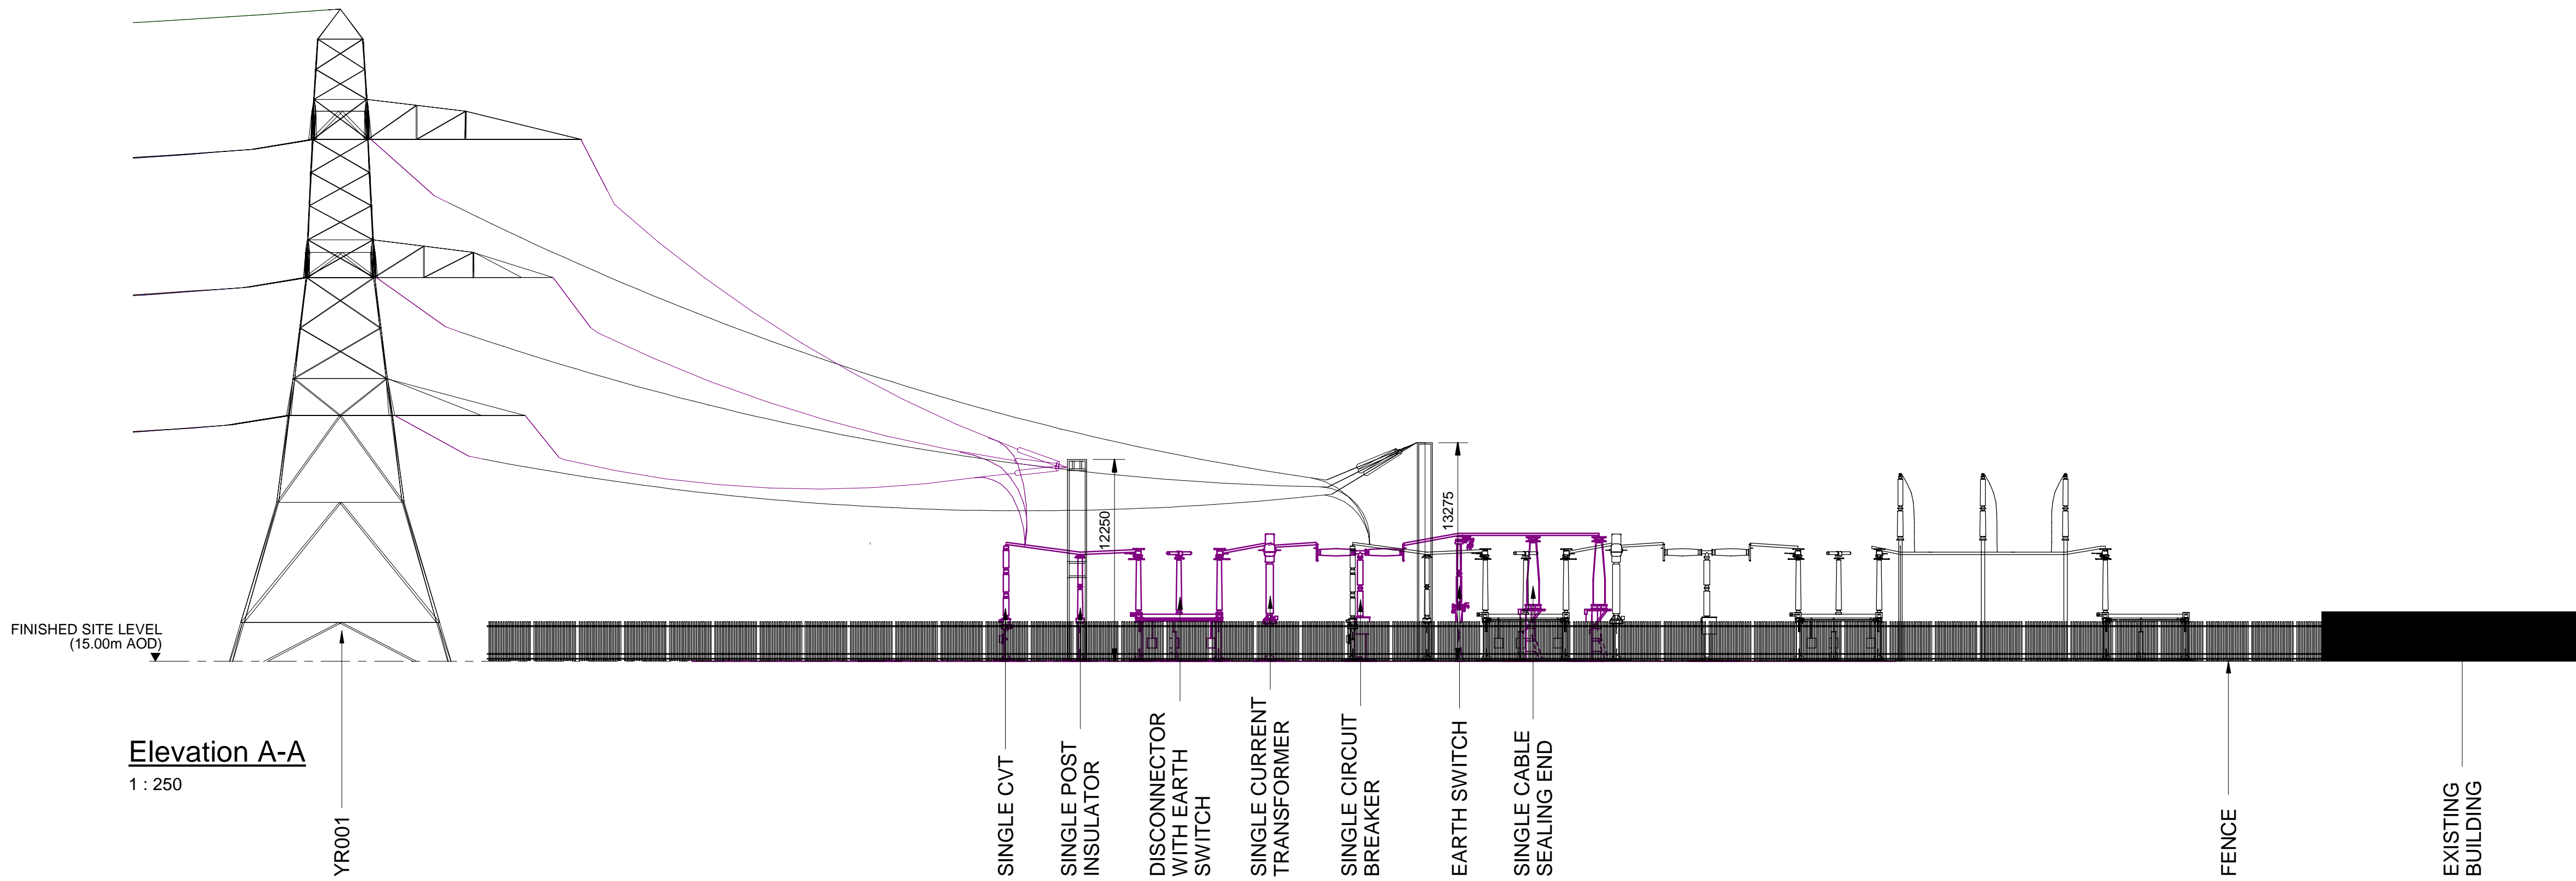
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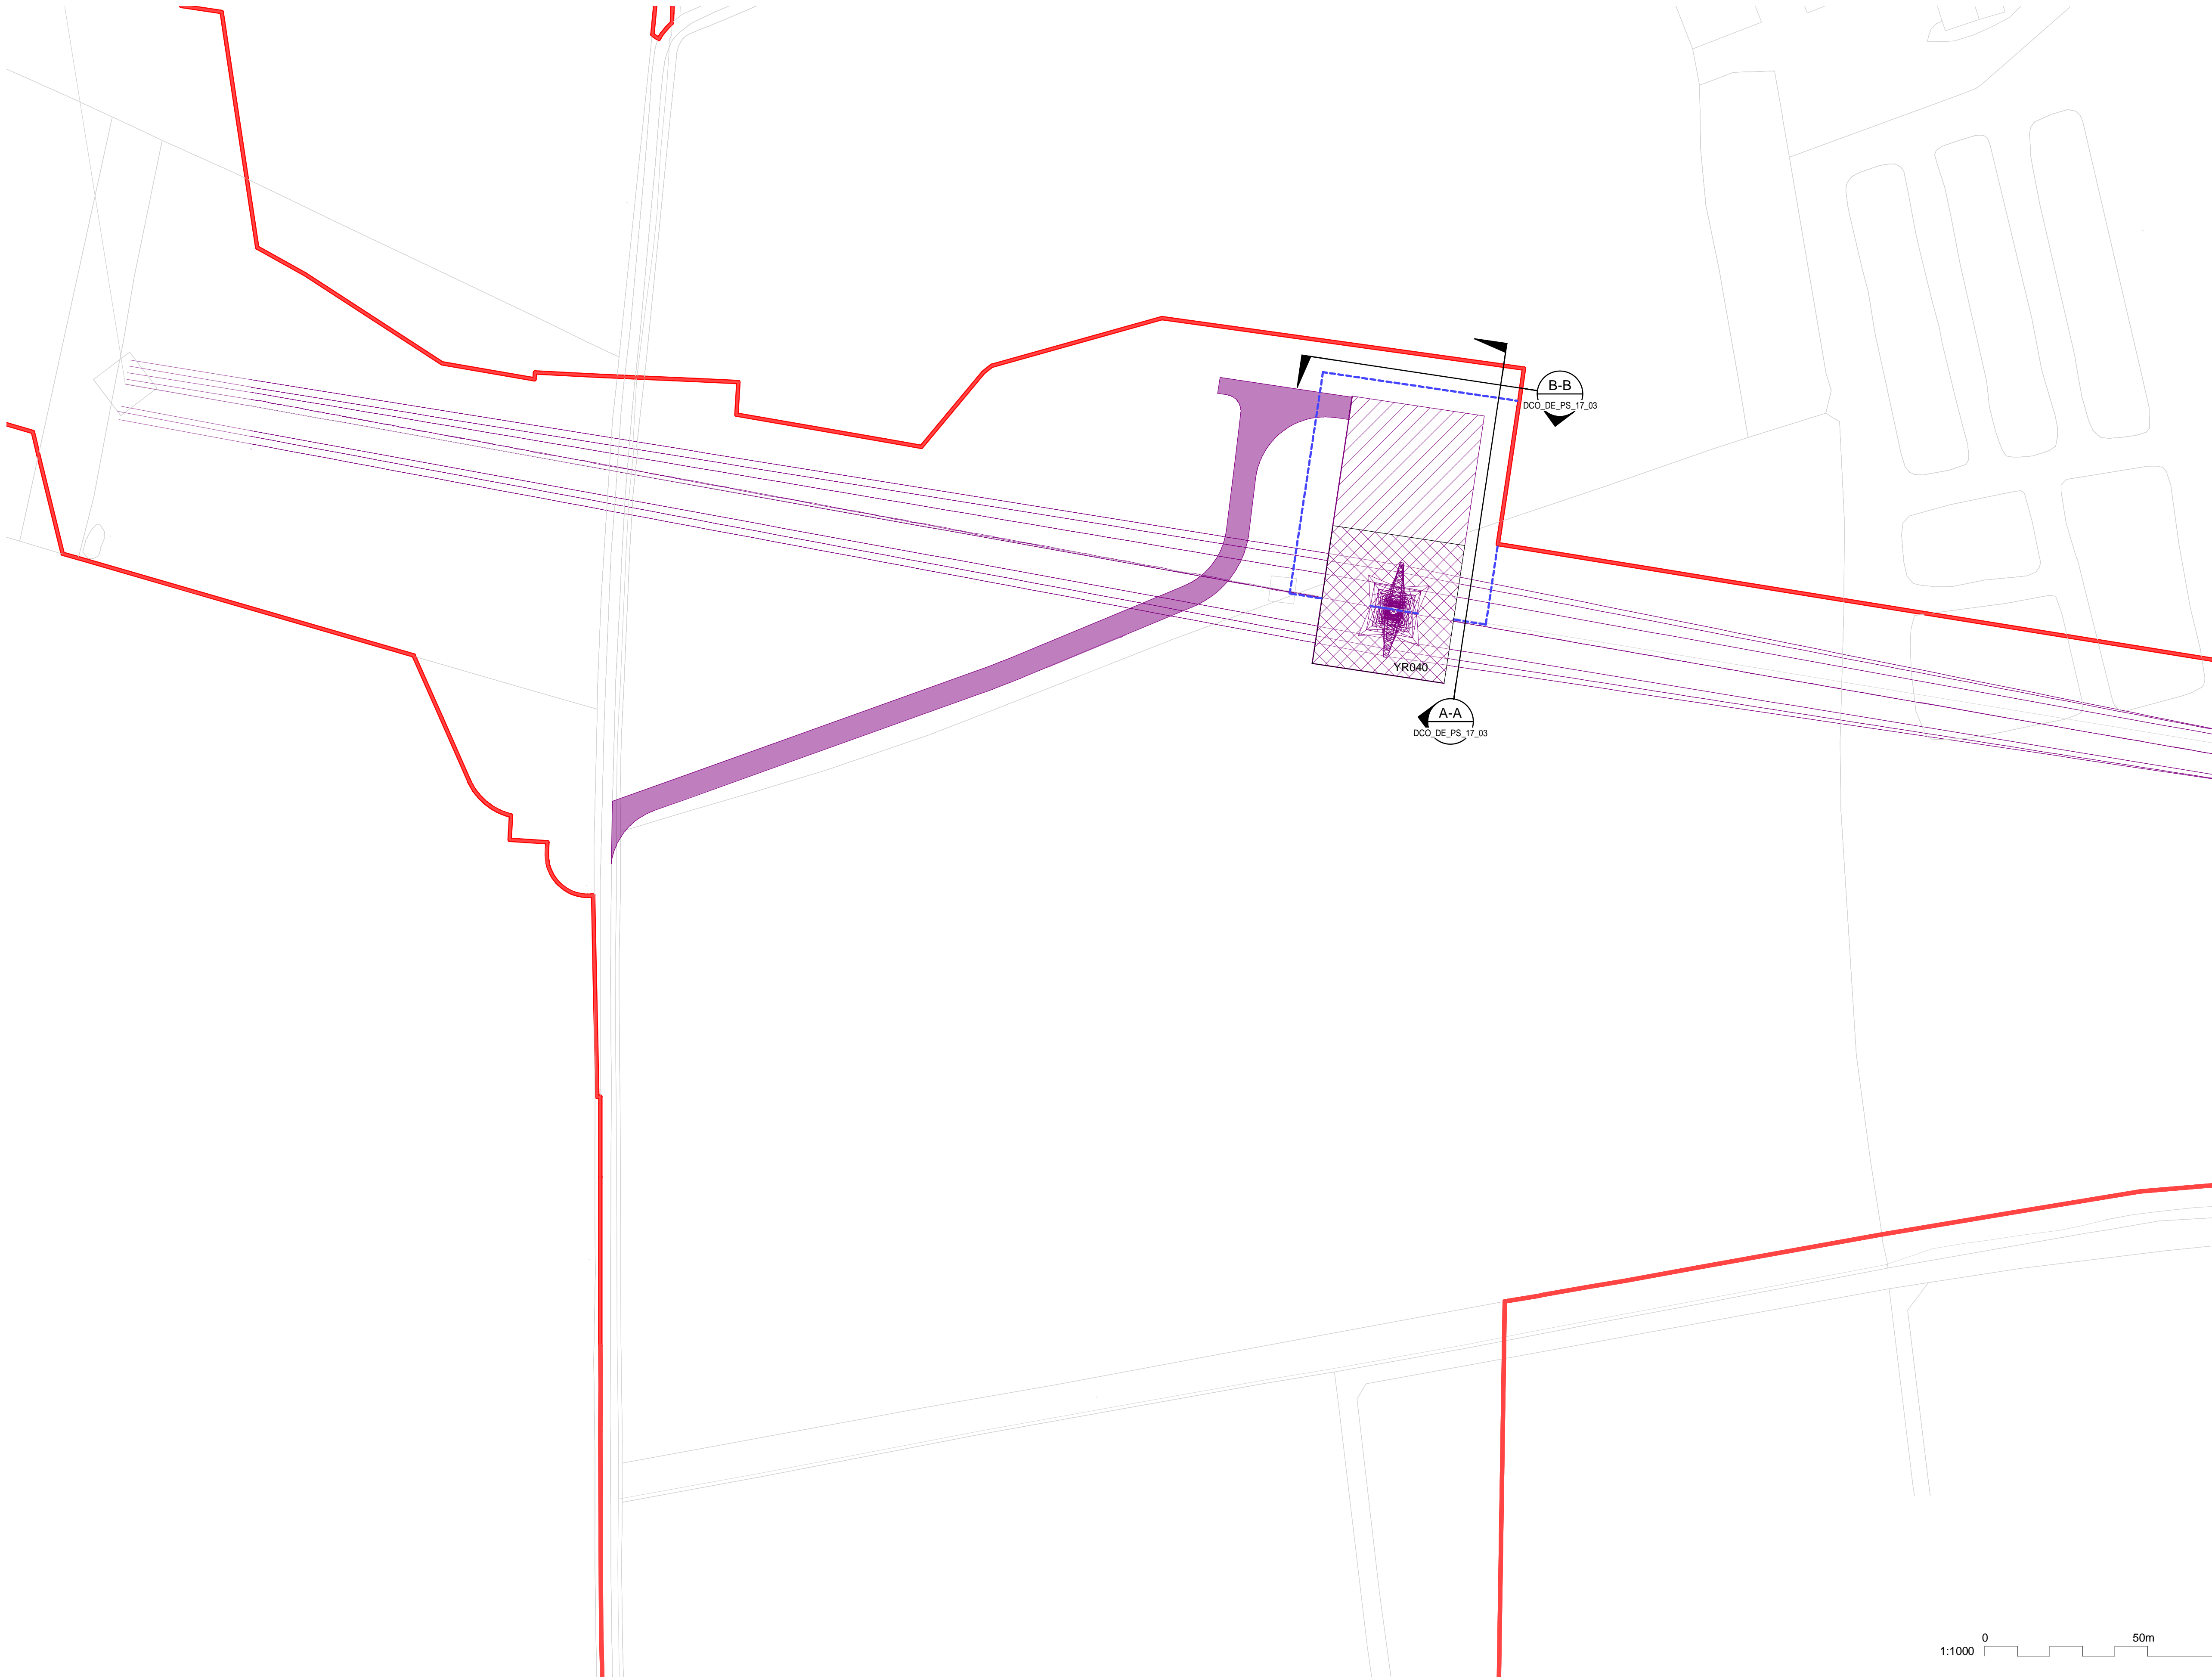
NATIONAL GRID
(YORKSHIRE GREEN ENERGY
ENABLEMENT PROJECT) ORDER
DESIGN DRAWING: INDICATIVE SUBSTATION
ELEVATION - OSBALDWICK
REGULATION 5(2)(o)
SHEET 3 OF 3

nationalgrid				
Application Number				
EN020024				
National Grid Drawing Reference				
DCO_DE/PS/16_03				
Scale	Sheet Size	Sheet	Issue	
1:250	A1	SHEET 3 OF 3	B	

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NATIONAL GRID (YORKSHIRE GREEN ENERGY ENABLEMENT PROJECT) ORDER
DESIGN DRAWING: PARAMETER PLAN FOR SHIPTON NORTH 400KV CABLE SEALING END COMPOUND
REGULATION 5(2)(o)
SHEET 1 OF 3



Legend

- ORDER LIMITS
- LIMITS OF DEVIATION FOR CSEC COMPOUND
- NEW EQUIPMENT, NEW SUBSTATION BOUNDARY & PERIMETER FENCE
- ZONE WITHIN WHICH NEW EQUIPMENT COULD BE LOCATED - (MAXIMUM HEIGHT - 15M)
- ZONE WITHIN CSEC WHERE OHL PYLON IS LOCATED
- PERMANENT ACCESS ROAD
- ELEVATION SYMBOL

Notes

- THIS DRAWING IS SCALED AT PAPER SIZE A1, THEREFORE ANY PRINTS TAKEN AT SMALLER SIZES WILL AFFECT ACCURACY OF THE MEASUREMENT UNITS AND SHOULD NOT BE SCALED AGAINST.
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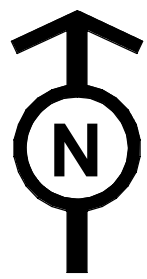
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Sheet X Centroid Coordinate: 456532
Sheet Y Centroid Coordinate: 459908
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B	26/04/23	DEADLINE 2 UPDATE	NB	SF	EMD
A	01/11/22	FOR DCO SUBMISSION	NB	SF	EMD
Issue	Date	Remarks	Drawn	Checked	Approved

Title
NATIONAL GRID
(YORKSHIRE GREEN ENERGY
ENABLEMENT PROJECT) ORDER
DESIGN DRAWING: PARAMETER PLAN FOR SHIPTON NORTH 400KV
CABLE SEALING END COMPOUND
REGULATION 5(2)(o)
SHEET 1 OF 3

nationalgrid

Application Number		EN020024			
National Grid Drawing Reference		DCO_DE/PS/17_01			
Scale	Sheet Size	Sheet	Issue		
1:1000	A1	SHEET 1 OF 3	B		



NATIONAL GRID (YORKSHIRE GREEN ENERGY ENABLEMENT PROJECT) ORDER
DESIGN DRAWING: INDICATIVE CABLE SEALING END COMPOUND LAYOUT - SHIPTON NORTH 400kV CABLE SEALING END COMPOUND
REGULATION 5(2)(o)
SHEET 2 OF 3

Legend

- ORDER LIMITS
- LIMITS OF DEVIATION FOR CSE COMPOUND
- NEW EQUIPMENT
- PERMANENT ACCESS ROAD
- TEMPORARY CONSTRUCTION COMPOUND, TEMPORARY ACCESS ROAD
- TEMPORARY DRAINAGE
- SINGLE CABLE SEALING END
- SINGLE SURGE ARRESTOR
- SINGLE POST INSULATOR
- SINGLE ANCHOR BLOCK
- EARTH SWITCH
- ELEVATION SYMBOL

Notes

- THIS DRAWING IS SCALED AT PAPER SIZE A1, THEREFORE ANY PRINTS TAKEN AT SMALLER SIZES WILL AFFECT ACCURACY OF THE MEASUREMENT UNITS AND SHOULD NOT BE SCALED AGAINST.
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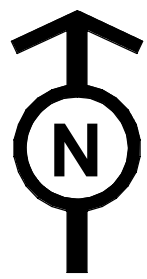
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B	26/04/23	DEADLINE 2 UPDATE	NB	SF	EMD
A	01/11/22	FOR DCO SUBMISSION	NB	SF	EMD
Issue	Date	Remarks	Drawn	Checked	Approved

Title
NATIONAL GRID
(YORKSHIRE GREEN ENERGY
ENABLEMENT PROJECT) ORDER
DESIGN DRAWING: INDICATIVE CABLE SEALING END COMPOUND LAYOUT
- SHIPTON NORTH 400kV CABLE SEALING END COMPOUND
REGULATION 5(2)(o)
SHEET 2 OF 3


nationalgrid

Application Number		EN020024			
National Grid Drawing Reference		DCO_DE/PS/17_02			
Scale	Sheet Size	Sheet	Issue		
1:1000	A1	SHEET 2 OF 3	B		





NATIONAL GRID (YORKSHIRE GREEN ENERGY ENABLEMENT PROJECT) ORDER
DESIGN DRAWING: INDICATIVE CABLE SEALING END COMPOUND ELEVATION - SHIPTON NORTH 400kV CABLE SEALING END COMPOUND
REGULATION 5(2)(o)
SHEET 3 OF 3

Legend

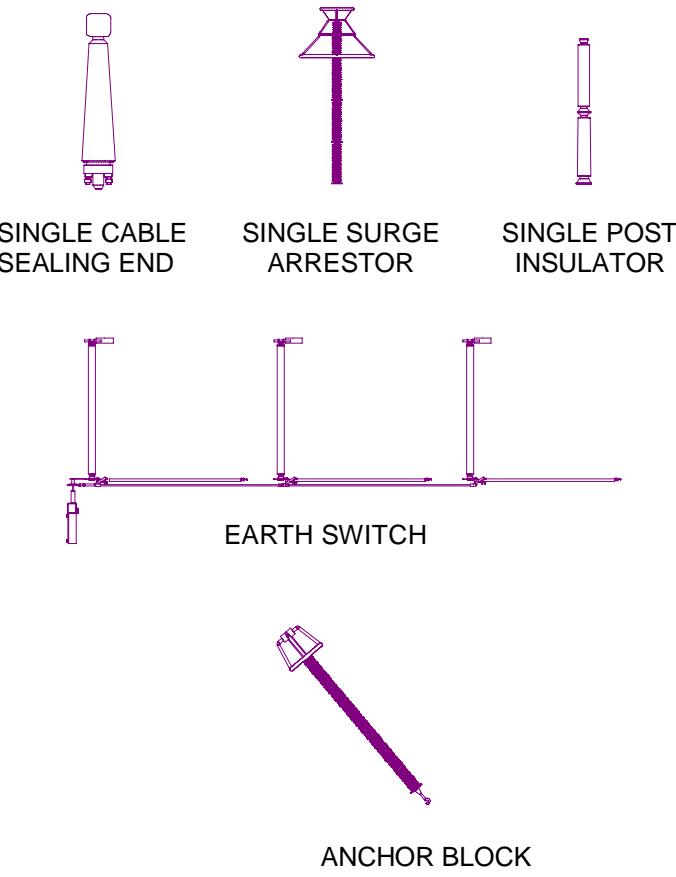


Notes

1. THIS DRAWING IS SCALED AT PAPER SIZE A1, THEREFORE ANY PRINTS TAKEN AT SMALLER SIZES WILL AFFECT ACCURACY OF THE MEASUREMENT UNITS AND SHOULD NOT BE SCALED AGAINST.
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3. NO UNAUTHORISED DISCLOSURE, STORAGE OR COPYING.
4. ALL SPATIAL COORDINATES RELATE TO THE ORDNANCE SURVEY, BRITISH NATIONAL GRID (OSGB36).
5. ALL DIMENSIONS ARE IN MILLIMETRES UNLESS OTHERWISE STATED.

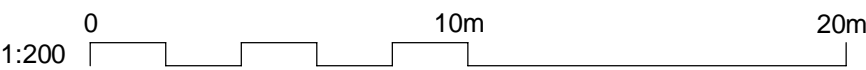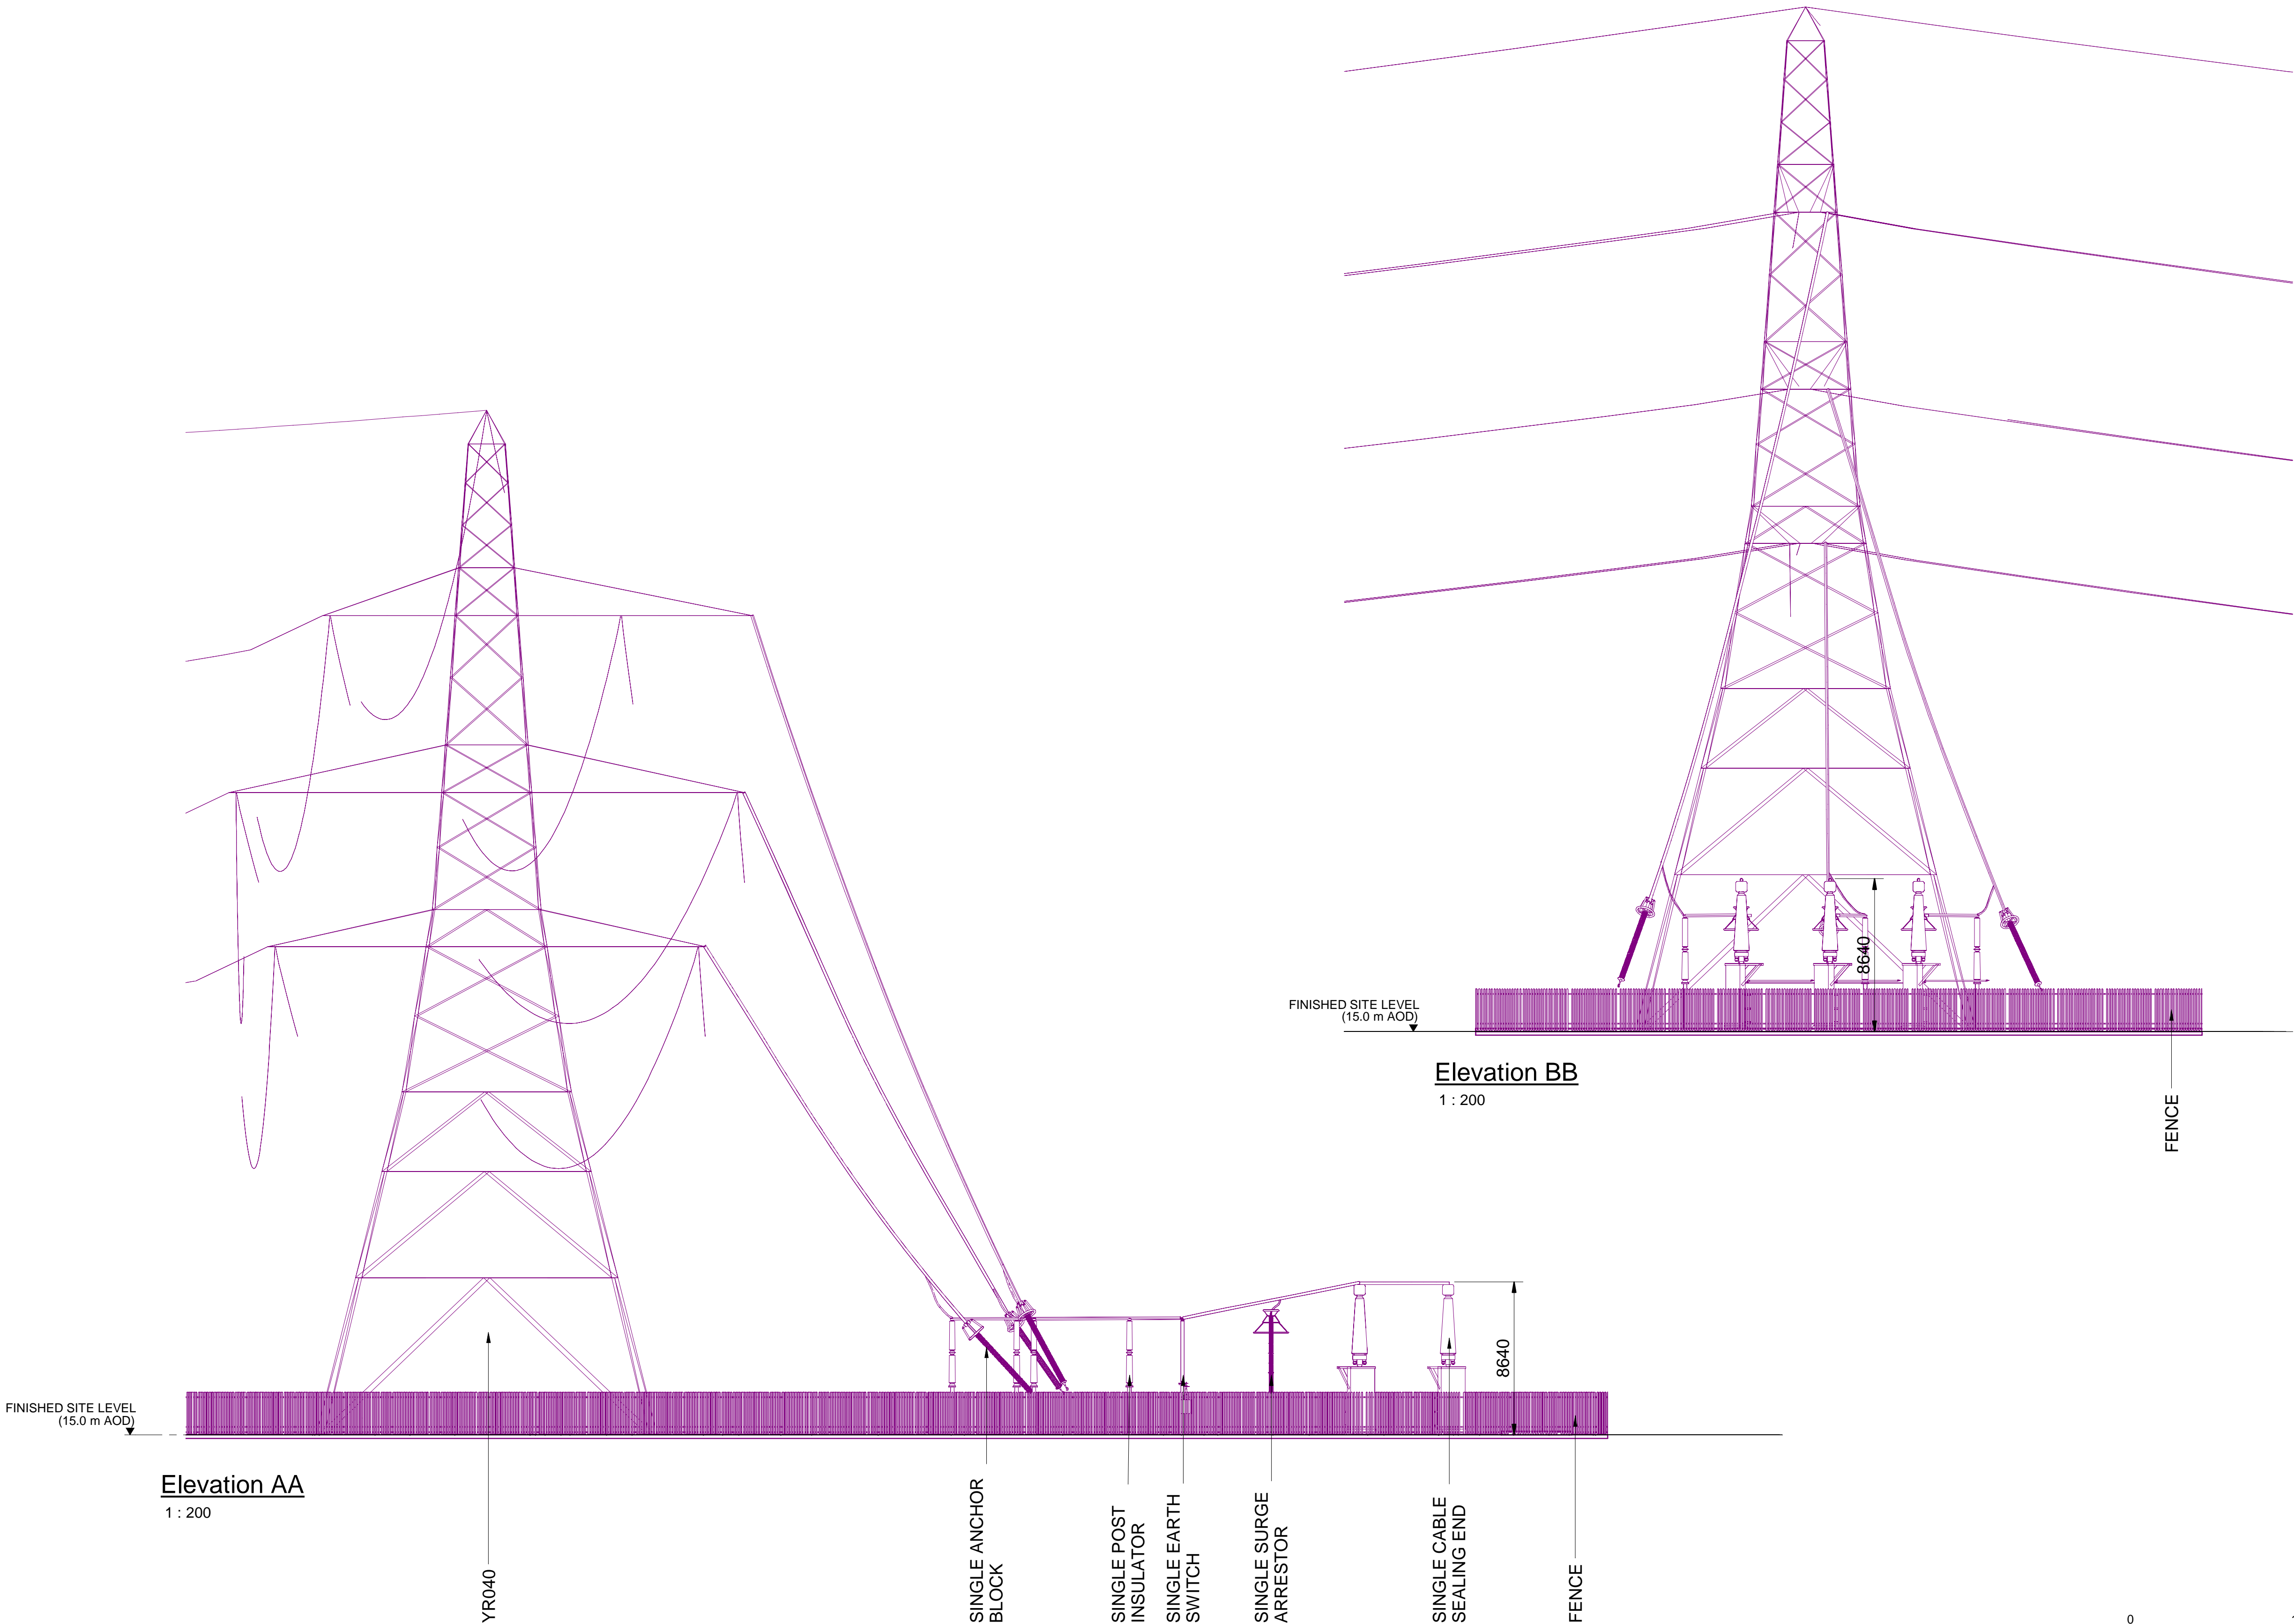

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A	01/11/22	FOR DCO SUBMISSION	NB	SF	EMD
Issue	Date	Remarks	Drawn	Checked	Approved
Title					
NATIONAL GRID (YORKSHIRE GREEN ENERGY ENABLEMENT PROJECT) ORDER DESIGN DRAWING: INDICATIVE CABLE SEALING END COMPOUND ELEVATION - SHIPTON NORTH 400kV CABLE SEALING END COMPOUND REGULATION 5(2)(o) SHEET 3 OF 3					
nationalgrid					
Application Number					
EN020024					
National Grid Drawing Reference					
DCO_DE/PS/17_03					
Scale	Sheet Size	Sheet	Issue		
1 : 200	A1	SHEET 3 OF 3	B		

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NATIONAL GRID (YORKSHIRE GREEN ENERGY ENABLEMENT PROJECT) ORDER
DESIGN DRAWING: PARAMETER PLAN FOR SHIPTON SOUTH 400KV CABLE SEALING END COMPOUND
REGULATION 5(2)(o)
SHEET 1 OF 3

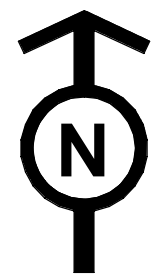Legend

- ORDER LIMITS
- LIMITS OF DEVIATION FOR CSE COMPOUND
- NEW EQUIPMENT, NEW SUBSTATION BOUNDARY & PERIMETER FENCE
- ZONE WITHIN WHICH NEW EQUIPMENT COULD BE LOCATED - (MAXIMUM HEIGHT - 15M)
- PERMANENT ACCESS ROAD
- ELEVATION SYMBOL

Notes

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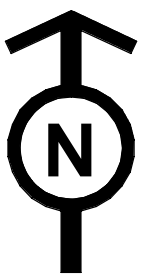
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Issue	Date	Remarks	Drawn	Checked	Approved

Title

NATIONAL GRID
(YORKSHIRE GREEN ENERGY
ENABLEMENT PROJECT) ORDER
DESIGN DRAWING: PARAMETER PLAN FOR SHIPTON SOUTH 400KV CABLE
SEALING END COMPOUND
REGULATION 5(2)(o)
SHEET 1 OF 3

nationalgrid			
Application Number		EN020024	
National Grid Drawing Reference		DCO_DE/PS/18_01	
Scale	Sheet Size	Sheet	Issue
1:1000	A1	SHEET 1 OF 3	B



NATIONAL GRID (YORKSHIRE GREEN ENERGY ENABLEMENT PROJECT) ORDER
DESIGN DRAWING: INDICATIVE CABLE SEALING END COMPOUND LAYOUT - SHIPTON SOUTH 400kV CABLE SEALING END COMPOUND
REGULATION 5(2)(o)
SHEET 2 OF 3

Legend

- ORDER LIMITS
- LIMITS OF DEVIATION FOR CSE COMPOUND
- NEW EQUIPMENT
- PERMANENT ACCESS ROAD
- TEMPORARY CONSTRUCTION COMPOUND, TEMPORARY ACCESS ROAD
- TEMPORARY DRAINAGE
- SINGLE CABLE SEALING END
- SINGLE SURGE ARRESTOR
- SINGLE POST INSULATOR
- SINGLE ANCHOR BLOCK
- GANTRY
- EARTH SWITCH
- ELEVATION SYMBOL

- Notes
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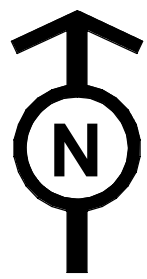
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Title
NATIONAL GRID
(YORKSHIRE GREEN ENERGY
ENABLEMENT PROJECT) ORDER
DESIGN DRAWING: INDICATIVE CABLE SEALING END COMPOUND LAYOUT
- SHIPTON SOUTH 400kV CABLE SEALING END COMPOUND
REGULATION 5(2)(o)
SHEET 2 OF 3


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National Grid Drawing Reference		DCO_DE/PS/18_02			
Scale	Sheet Size	Sheet	Issue		
1:750	A1	SHEET 2 OF 3	B		




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DESIGN DRAWING: INDICATIVE CABLE SEALING END COMPOUND ELEVATION - SHIPTON SOUTH 400kV CABLE SEALING END COMPOUND
REGULATION 5(2)(o)
SHEET 3 OF 3

Legend

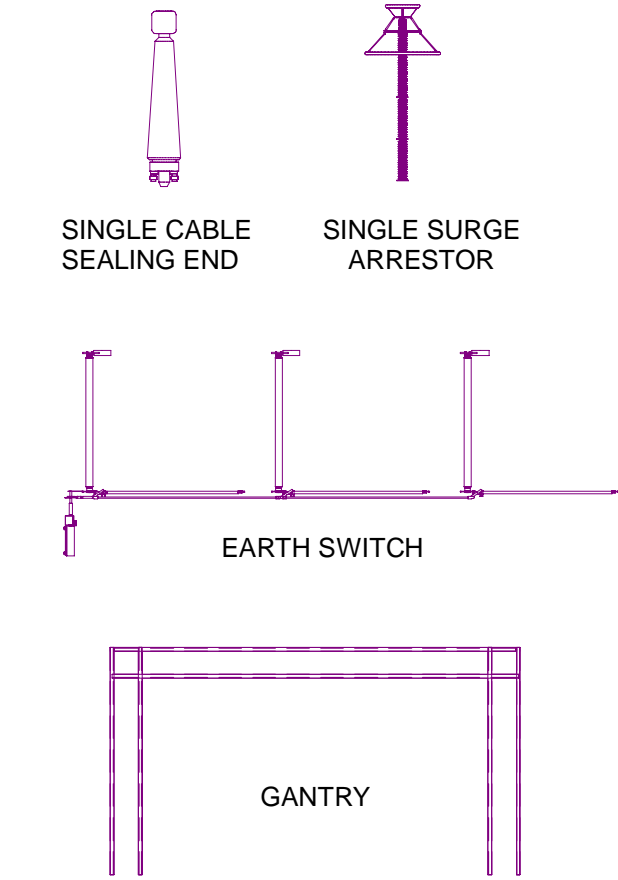

Notes

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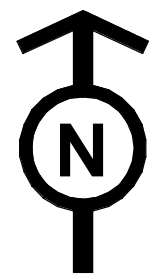

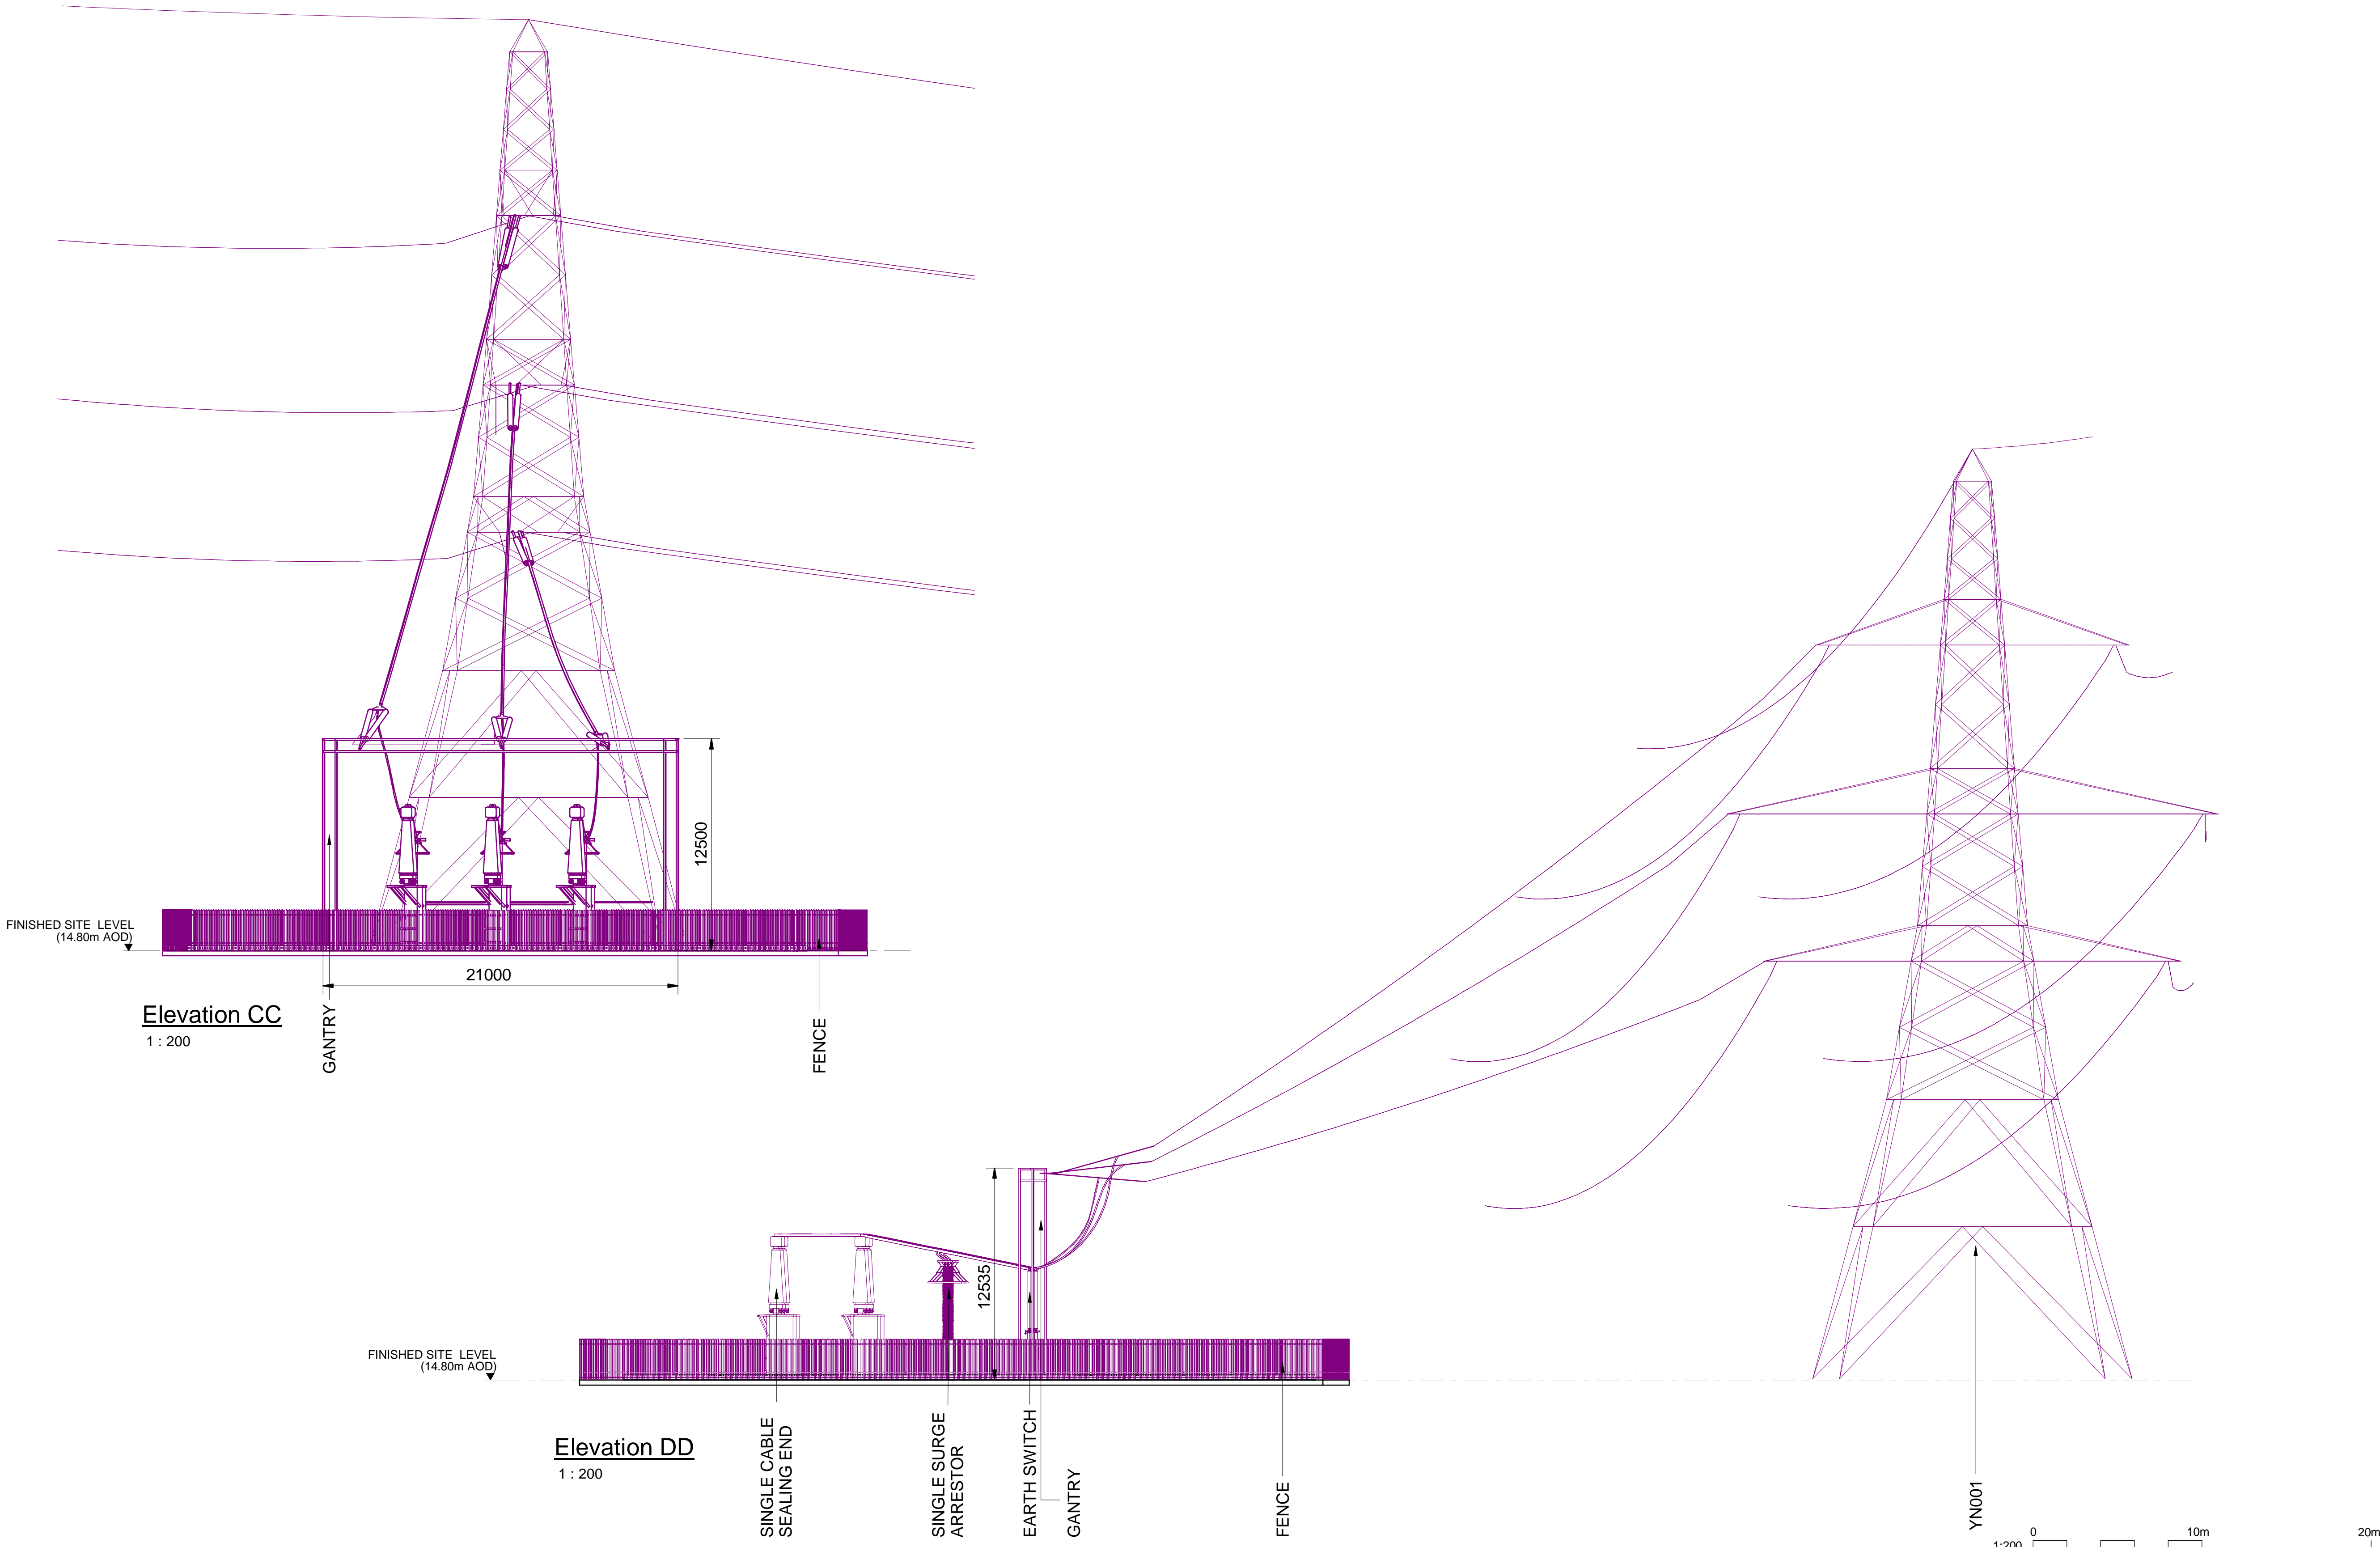
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A	01/11/22	FOR DCO SUBMISSION	NB	SF	EMD
Issue	Date	Remarks	Drawn	Checked	Approved

Title
NATIONAL GRID
(YORKSHIRE GREEN ENERGY
ENABLEMENT PROJECT) ORDER
DESIGN DRAWING: INDICATIVE CABLE SEALING END COMPOUND
ELEVATION - SHIPTON SOUTH 400kV CABLE SEALING END COMPOUND
REGULATION 5(2)(o)
SHEET 3 OF 3

nationalgrid			
<u>Application Number</u>		EN020024	
<u>National Grid Drawing Reference</u>			
DCO_DE/PS/18_03			
Scale	Sheet Size	Sheet	Issue
1 : 200	A1	SHEET 3 OF 3	B

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NATIONAL GRID (YORKSHIRE GREEN ENERGY ENABLEMENT PROJECT) ORDER
DESIGN DRAWING: PARAMETER PLAN FOR TADCASTER WEST 275KV CABLE SEALING END COMPOUND
REGULATION 5(2)(o)
SHEET 1 OF 3

Legend

- ORDER LIMITS
- EXISTING EQUIPMENT
- NEW EQUIPMENT, NEW SUBSTATION BOUNDARY & PERIMETER FENCE
- LIMITS OF DEVISTAION
- ZONE WITHIN WHICH NEW EQUIPMENT COULD BE LOCATED - (MAXIMUM HEIGHT - 15m)
- PERMANENT ACCESS ROAD
- ELEVATION SYMBOL

Notes

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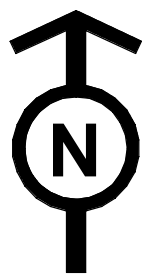
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Sheet Y Centroid Coordinate: 441680
BACKGROUND MAPPING INFORMATION HAS BEEN REPRODUCED FROM THE ORDNNANCE SURVEY BY PERMISSION OF ORDNNANCE SURVEY OF THE CONTROLLER OF HER MAJESTY'S STATIONERY OFFICE. © CROWN OFFICE COPYRIGHT ORDNNANCE SURVEY. BLUESKY INTERNATIONAL LTD © NATIONAL GRID ELECTRICITY -100024241.

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Issue	Date	Remarks	Drawn	Checked	Approved

Title
NATIONAL GRID
(YORKSHIRE GREEN ENERGY
ENABLEMENT PROJECT) ORDER
DESIGN DRAWING: PARAMETER PLAN FOR TADCASTER WEST 275KV
CABLE SEALING END COMPOUND
REGULATION 5(2)(o)
SHEET 1 OF 3

nationalgrid

<u>Application Number</u>		EN020024	
<u>National Grid Drawing Reference</u>			
DCO_DE/PS/19_01			
Scale	Sheet Size	Sheet	Issue
1:1000	A1	SHEET 1 OF 3	B



NATIONAL GRID (YORKSHIRE GREEN ENERGY ENABLEMENT PROJECT) ORDER
DESIGN DRAWING: INDICATIVE CABLE SEALING END COMPOUND LAYOUT - TADCASTER WEST 275kV CABLE SEALING END COMPOUND
REGULATION 5(2)(o)
SHEET 2 OF 3

Legend

- ORDER LIMITS
- EXISTING EQUIPMENT
- NEW EQUIPMENT, NEW SUBSTATION BOUNDARY & PERIMETER FENCE
- LIMITS OF DEVIATION
- TEMPORARY CONSTRUCTION COMPOUND AND TEMPORARY ACCESS ROAD
- PERMANENT ACCESS ROAD
- TEMPORARY DRAINAGE
- SINGLE CABLE SEALING END
- SURGE ARRESTOR
- GANTRY
- EARTH SWITCH
- ELEVATION SYMBOL

Notes

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Sheet X Centroid Coordinate: 446050
Sheet Y Centroid Coordinate: 441680
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Issue	Date	Remarks	Drawn	Checked	Approved


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TADCASTER WEST 275kV CABLE SEALING END COMPOUND
REGULATION 5(2)(o)
SHEET 2 OF 3

nationalgrid

<u>Application Number</u>		EN020024	
<u>National Grid Drawing Reference</u>			
DCO_DE/PS/19_02			
Scale	Sheet Size	Sheet	Issue
1:1000	A1	SHEET 2 OF 3	B


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DESIGN DRAWING: INDICATIVE CABLE SEALING END COMPOUND ELEVATION - TADCASTER WEST 275kV CABLE SEALING END COMPOUND
REGULATION 5(2)(o)
SHEET 3 OF 3

Legend

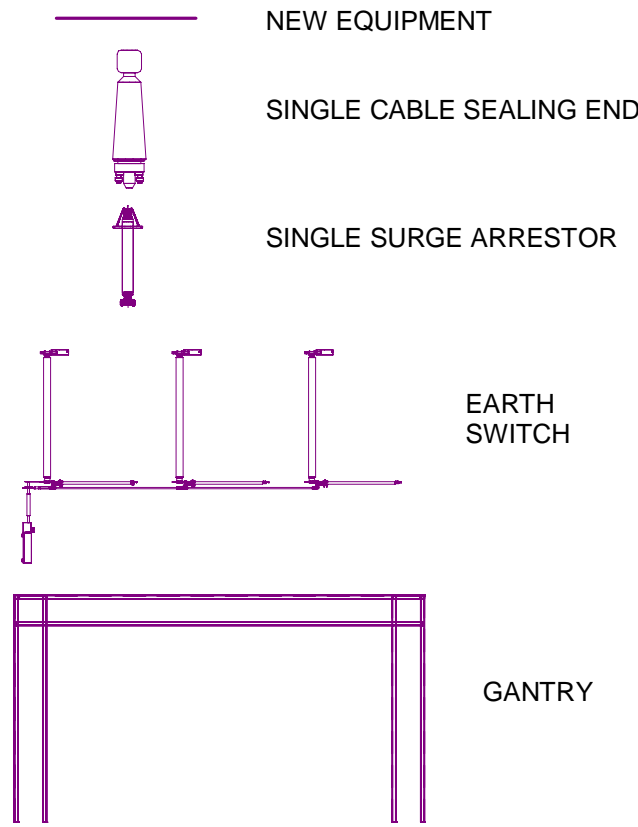

Notes

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Issue	Date	Remarks	Drawn	Checked	Approved

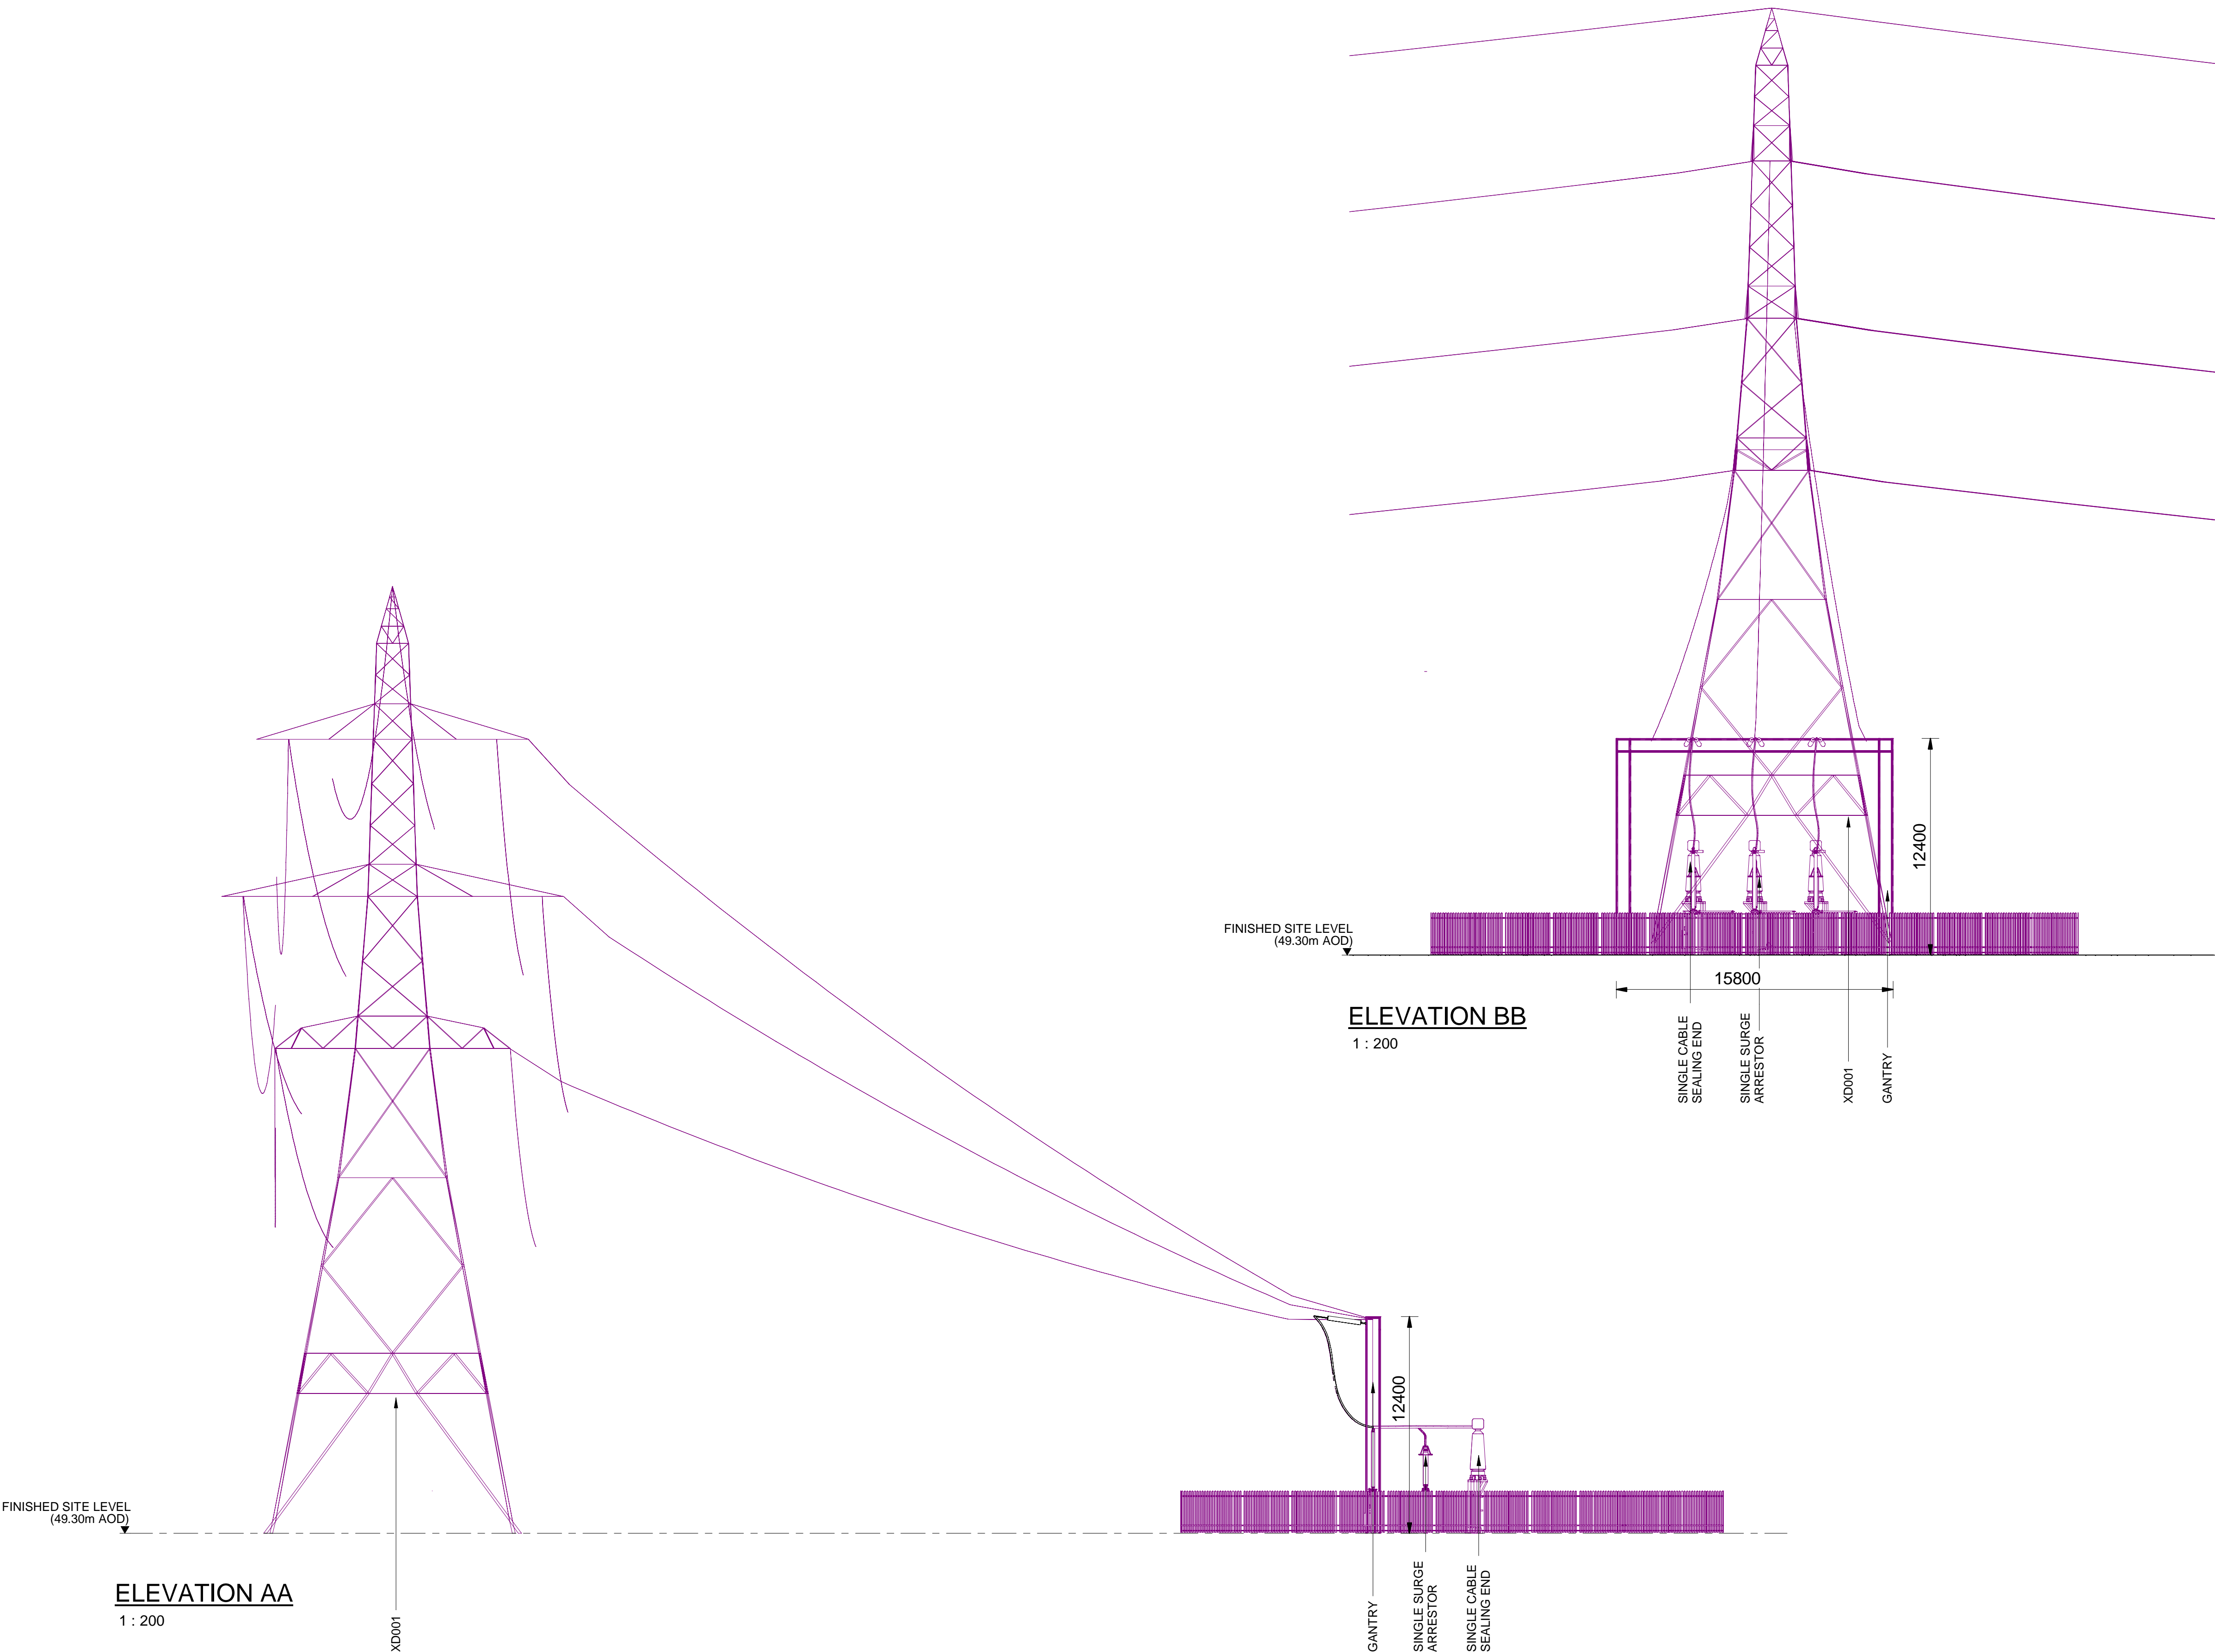
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NATIONAL GRID
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DESIGN DRAWING: INDICATIVE CABLE SEALING END COMPOUND
ELEVATION - TADCASTER WEST 275kV CABLE SEALING END COMPOUND
REGULATION 5(2)(o)
SHEET 3 OF 3


nationalgrid

<u>Application Number</u>		EN020024	
<u>National Grid Drawing Reference</u>			
DCO_DE/PS/19_03			
Scale	Sheet Size	Sheet	Issue
1 : 200	A1	SHEET 3 OF 3	B

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NATIONAL GRID (YORKSHIRE GREEN ENERGY ENABLEMENT PROJECT) ORDER
DESIGN DRAWING: PARAMETER PLAN FOR TADCASTER EAST 275KV CABLE SEALING END COMPOUND
REGULATION 5(2)(o)
SHEET 1 OF 3

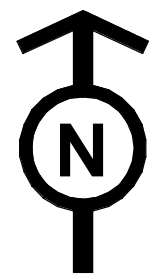

Legend

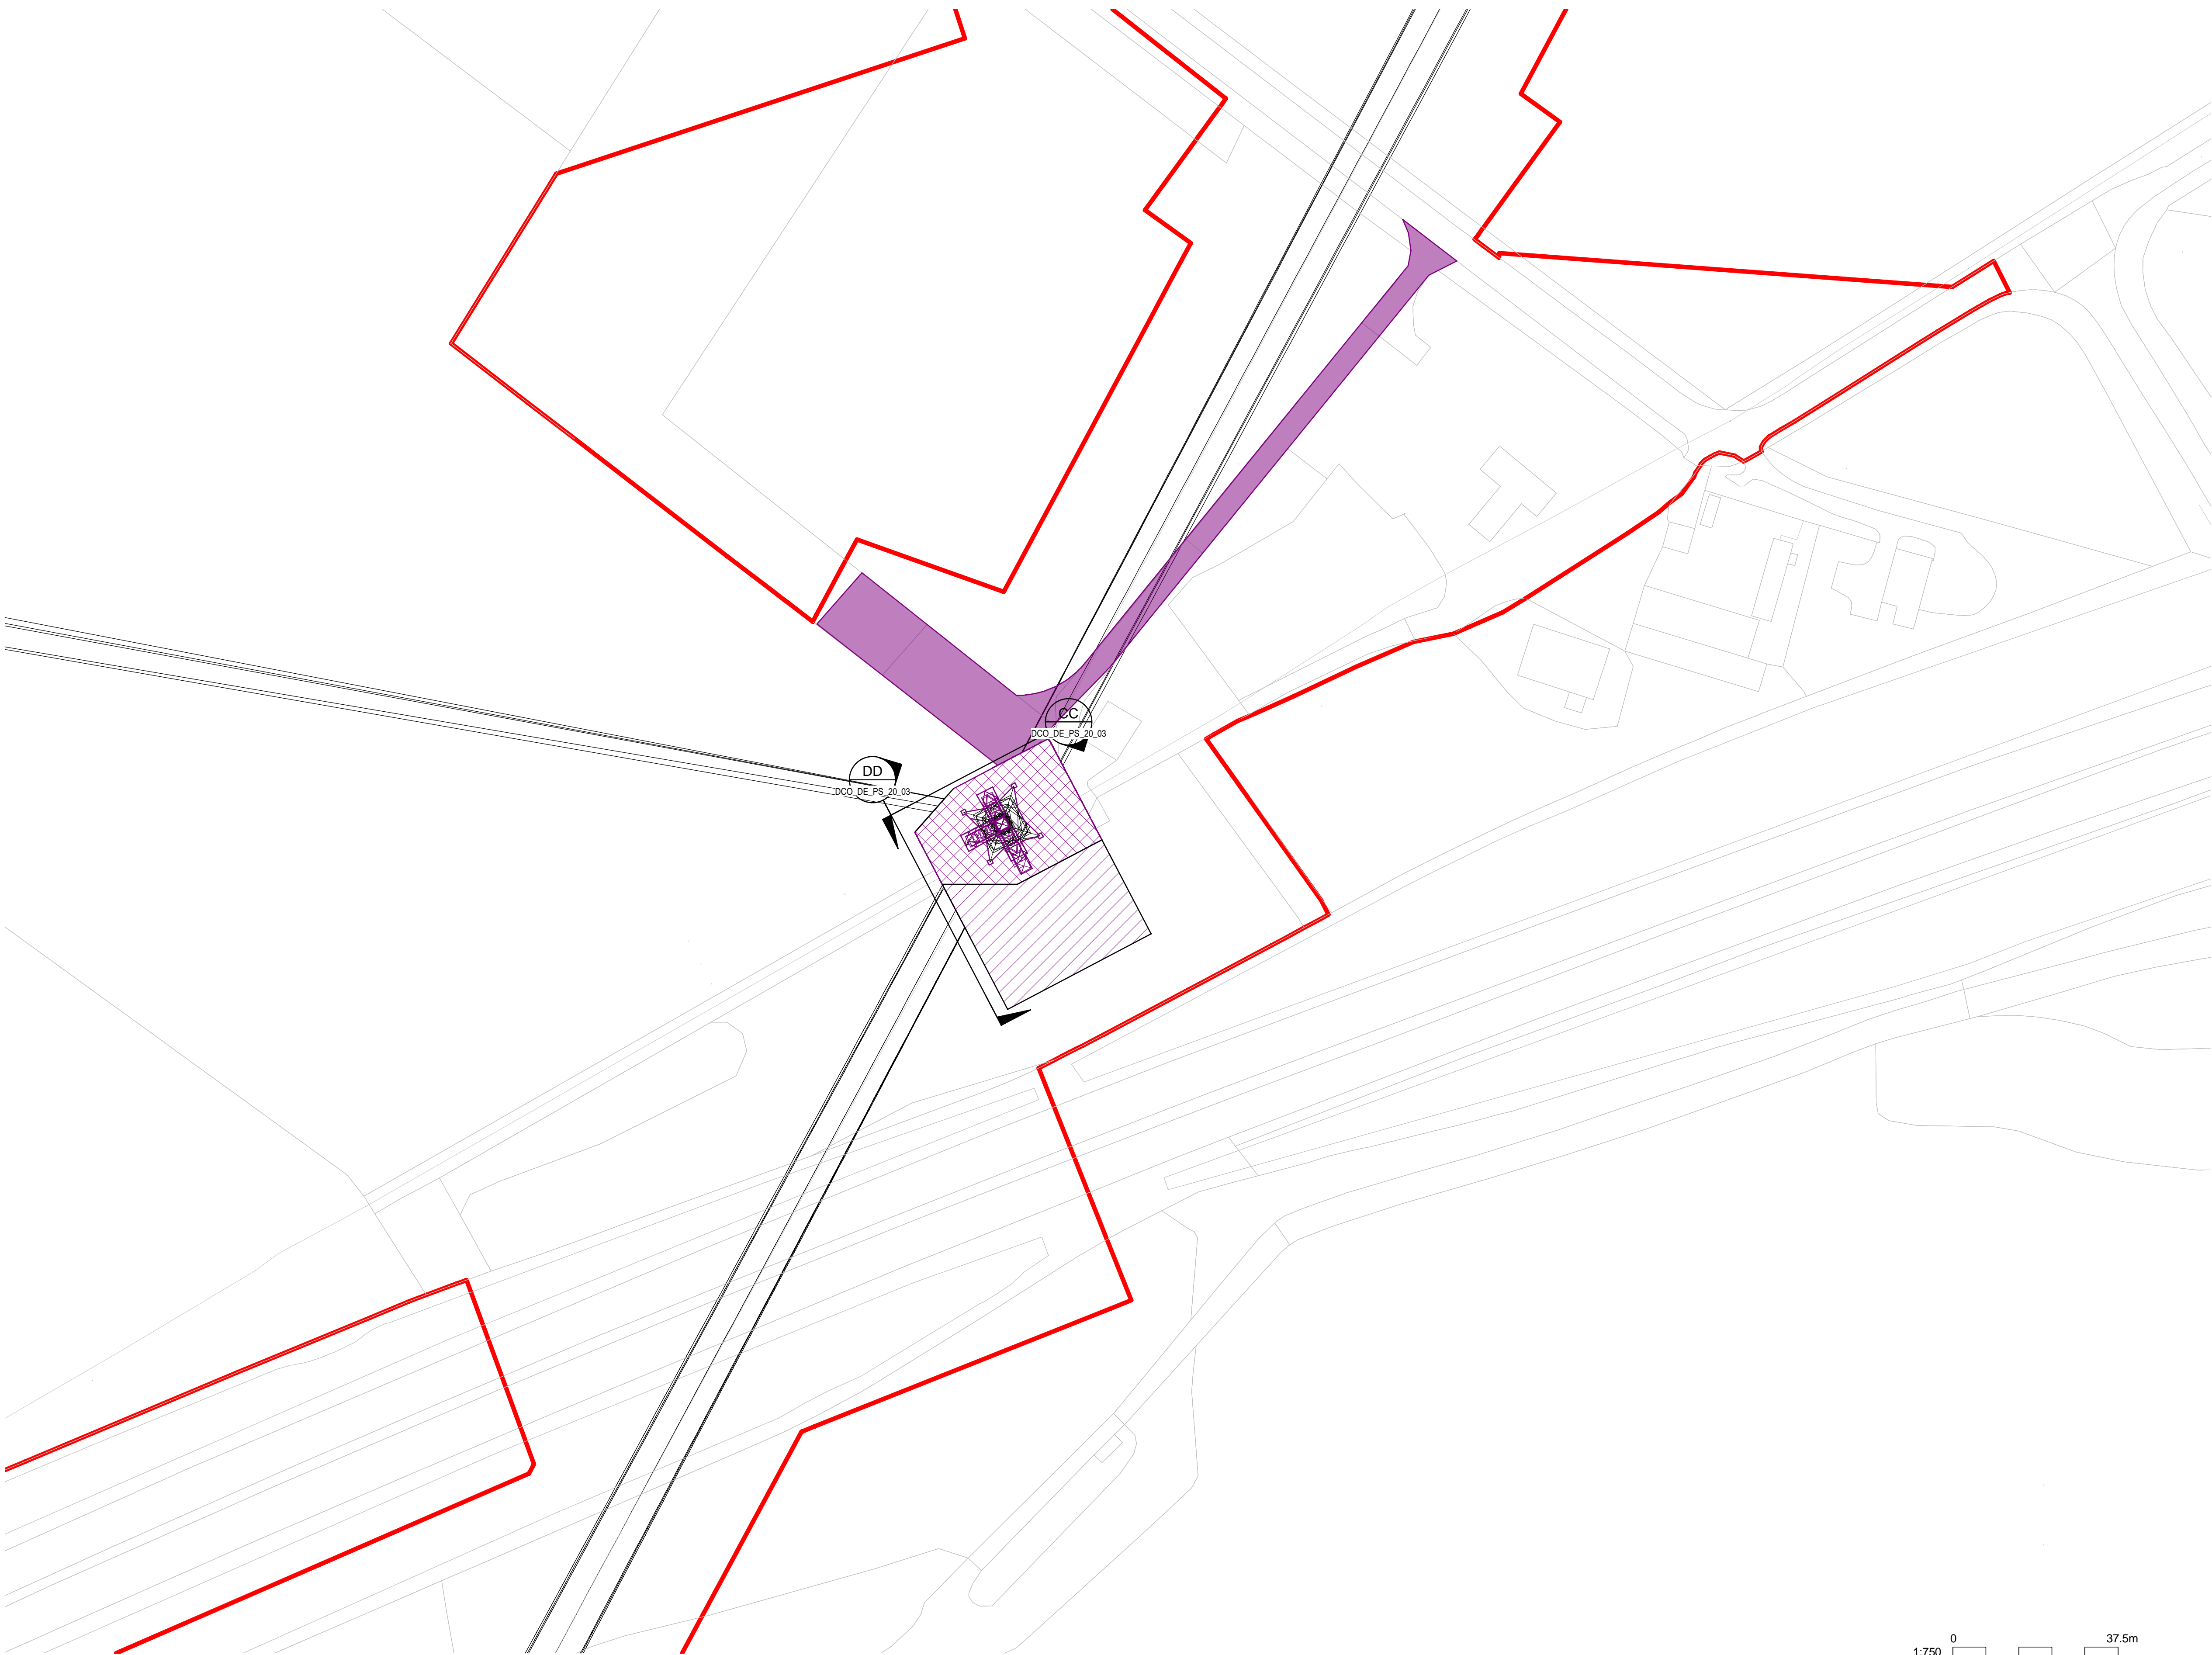- ORDER LIMITS
- EXISTING EQUIPMENT
- NEW EQUIPMENT, NEW SUBSTATION BOUNDARY & PERIMETER FENCE
- ZONE WITHIN WHICH NEW EQUIPMENT COULD BE LOCATED - (MAXIMUM HEIGHT - 15m)
- ZONE WITHIN WHICH MODIFICATIONS TO EXISTING PYLON MAY OCCUR
- PERMANENT ACCESS ROAD
- ELEVATION SYMBOL

Notes

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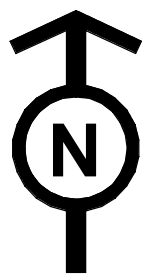
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Issue	Date	Remarks	Drawn	Checked	Approved


NATIONAL GRID
(YORKSHIRE GREEN ENERGY
ENABLEMENT PROJECT) ORDER
DESIGN DRAWING: PARAMETER PLAN FOR TADCASTER EAST 275KV CABLE
SEALING END COMPOUND
REGULATION 5(2)(o)
SHEET 1 OF 3

nationalgrid

Application Number		EN020024	
National Grid Drawing Reference		DCO_DE/PS/20_01	
Scale	Sheet Size	Sheet	Issue
1:750	A1	SHEET 1 OF 3	B



NATIONAL GRID (YORKSHIRE GREEN ENERGY ENABLEMENT PROJECT) ORDER
DESIGN DRAWING: INDICATIVE CABLE SEALING END COMPOUND LAYOUT - TADCASTER EAST 275kV CABLE SEALING END COMPOUND
REGULATION 5(2)(o)
SHEET 2 OF 3

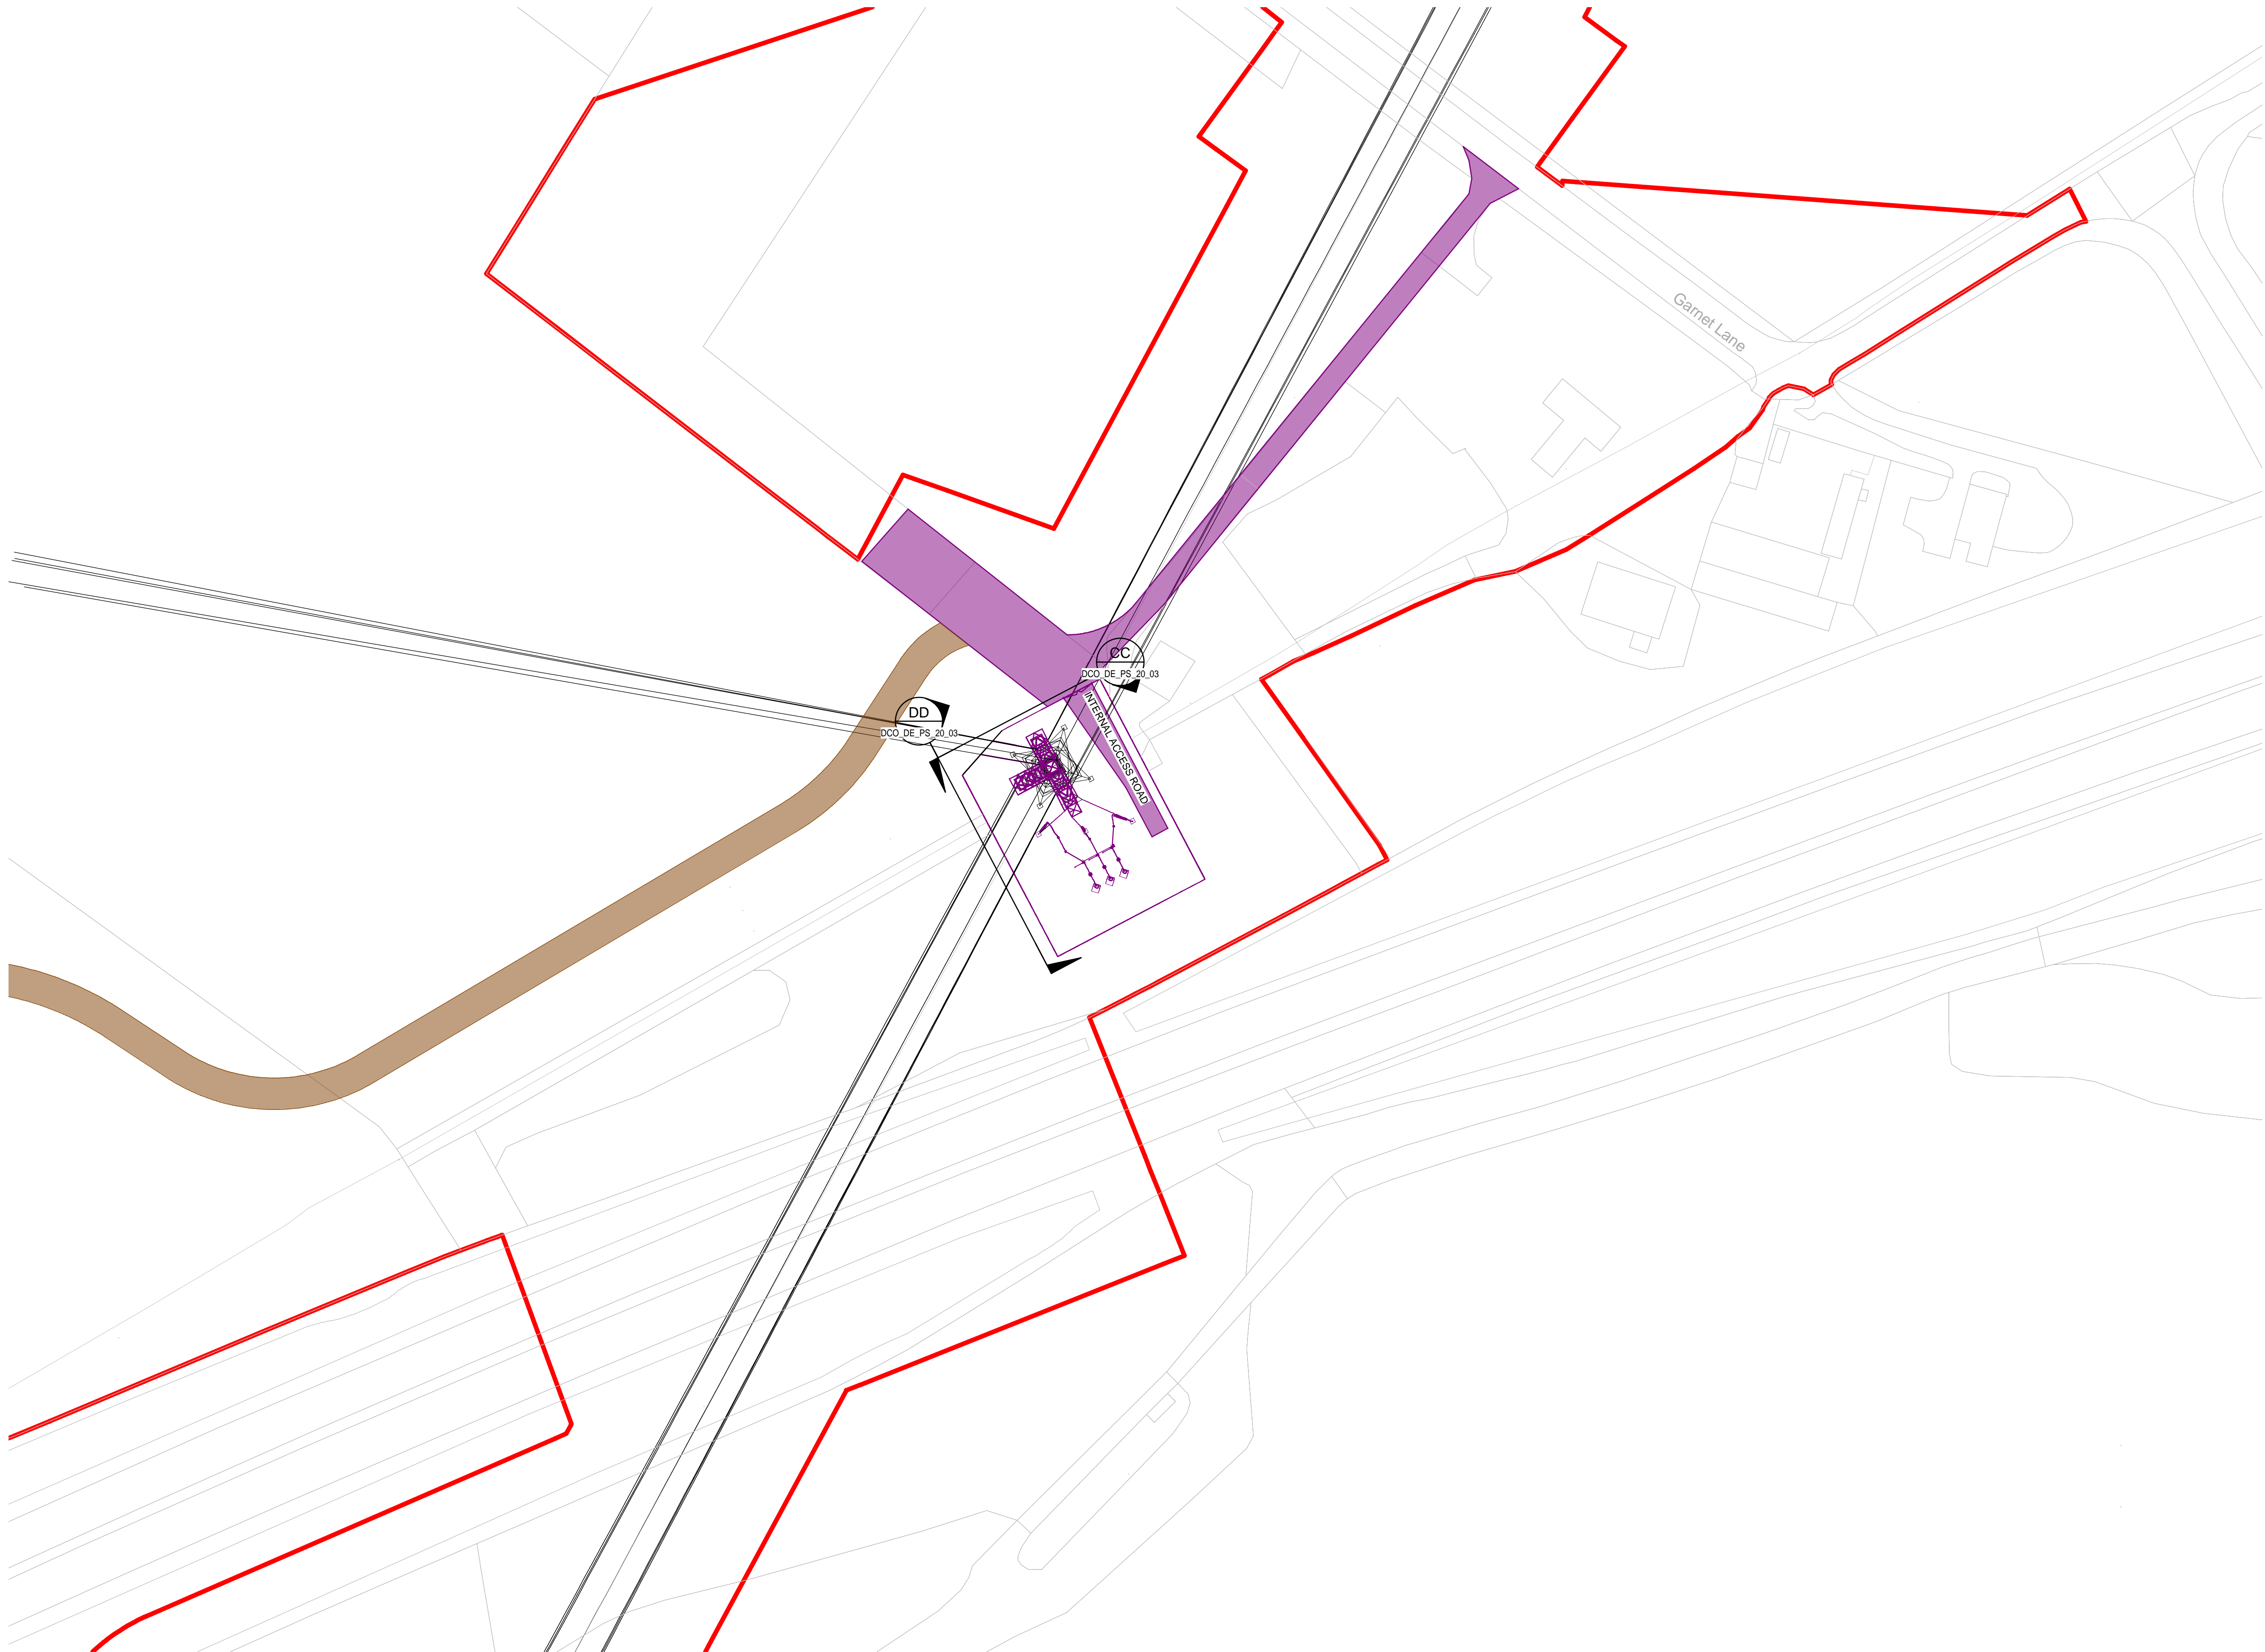

Legend

- ORDER LIMITS
- NEW EQUIPMENT, NEW SUBSTATION BOUNDARY & PERIMETER FENCE
- TEMPORARY CONSTRUCTION COMPOUND AND TEMPORARY ACCESS ROAD
- PERMANENT ACCESS ROAD
- SINGLE CABLE SEALING END
- SURGE ARRESTOR
- GANTRY
- EARTH SWITCH
- ANCHOR BLOCK
- ELEVATION SYMBOL

Notes


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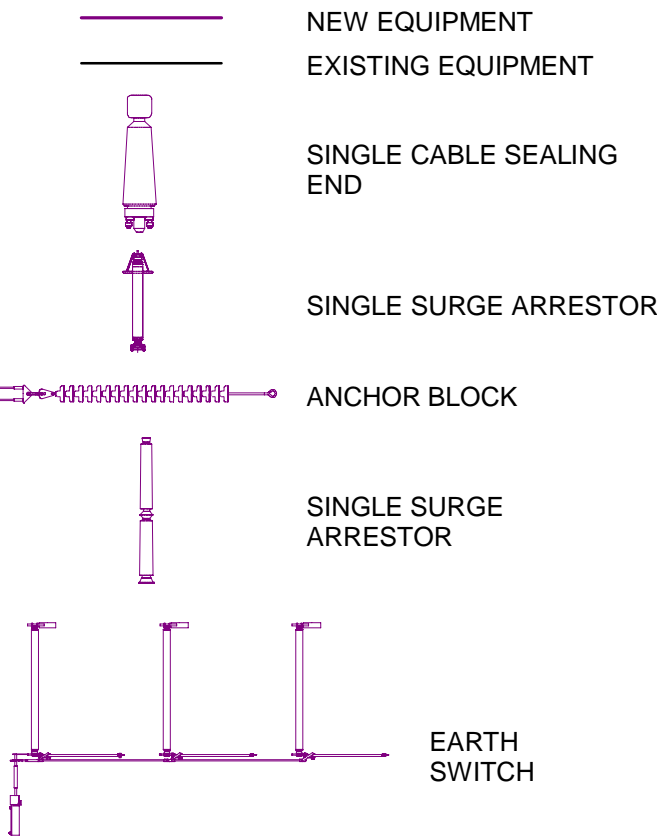
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ENABLEMENT PROJECT) ORDER
DESIGN DRAWING: INDICATIVE CABLE SEALING END COMPOUND LAYOUT -
TADCASTER EAST 275kV CABLE SEALING END COMPOUND
REGULATION 5(2)(o)
SHEET 2 OF 3

nationalgrid					
Application Number					
EN020024					
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DCO_DE/PS/20_02					
Scale	Sheet Size	Sheet	Issue		
1:750	A1	SHEET 2 OF 3	B		






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DESIGN DRAWING: INDICATIVE CABLE SEALING END COMPOUND ELEVATION - TADCASTER EAST 275kV CABLE SEALING END COMPOUND
REGULATION 5(2)(o)
SHEET 3 OF 3

Legend

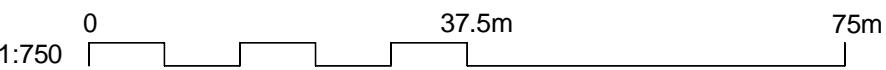

Notes

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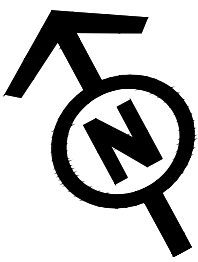
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Issue	Date	Remarks	Drawn	Checked	Approved

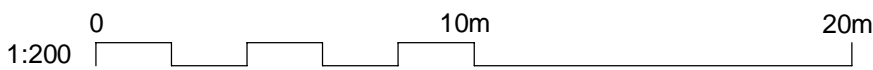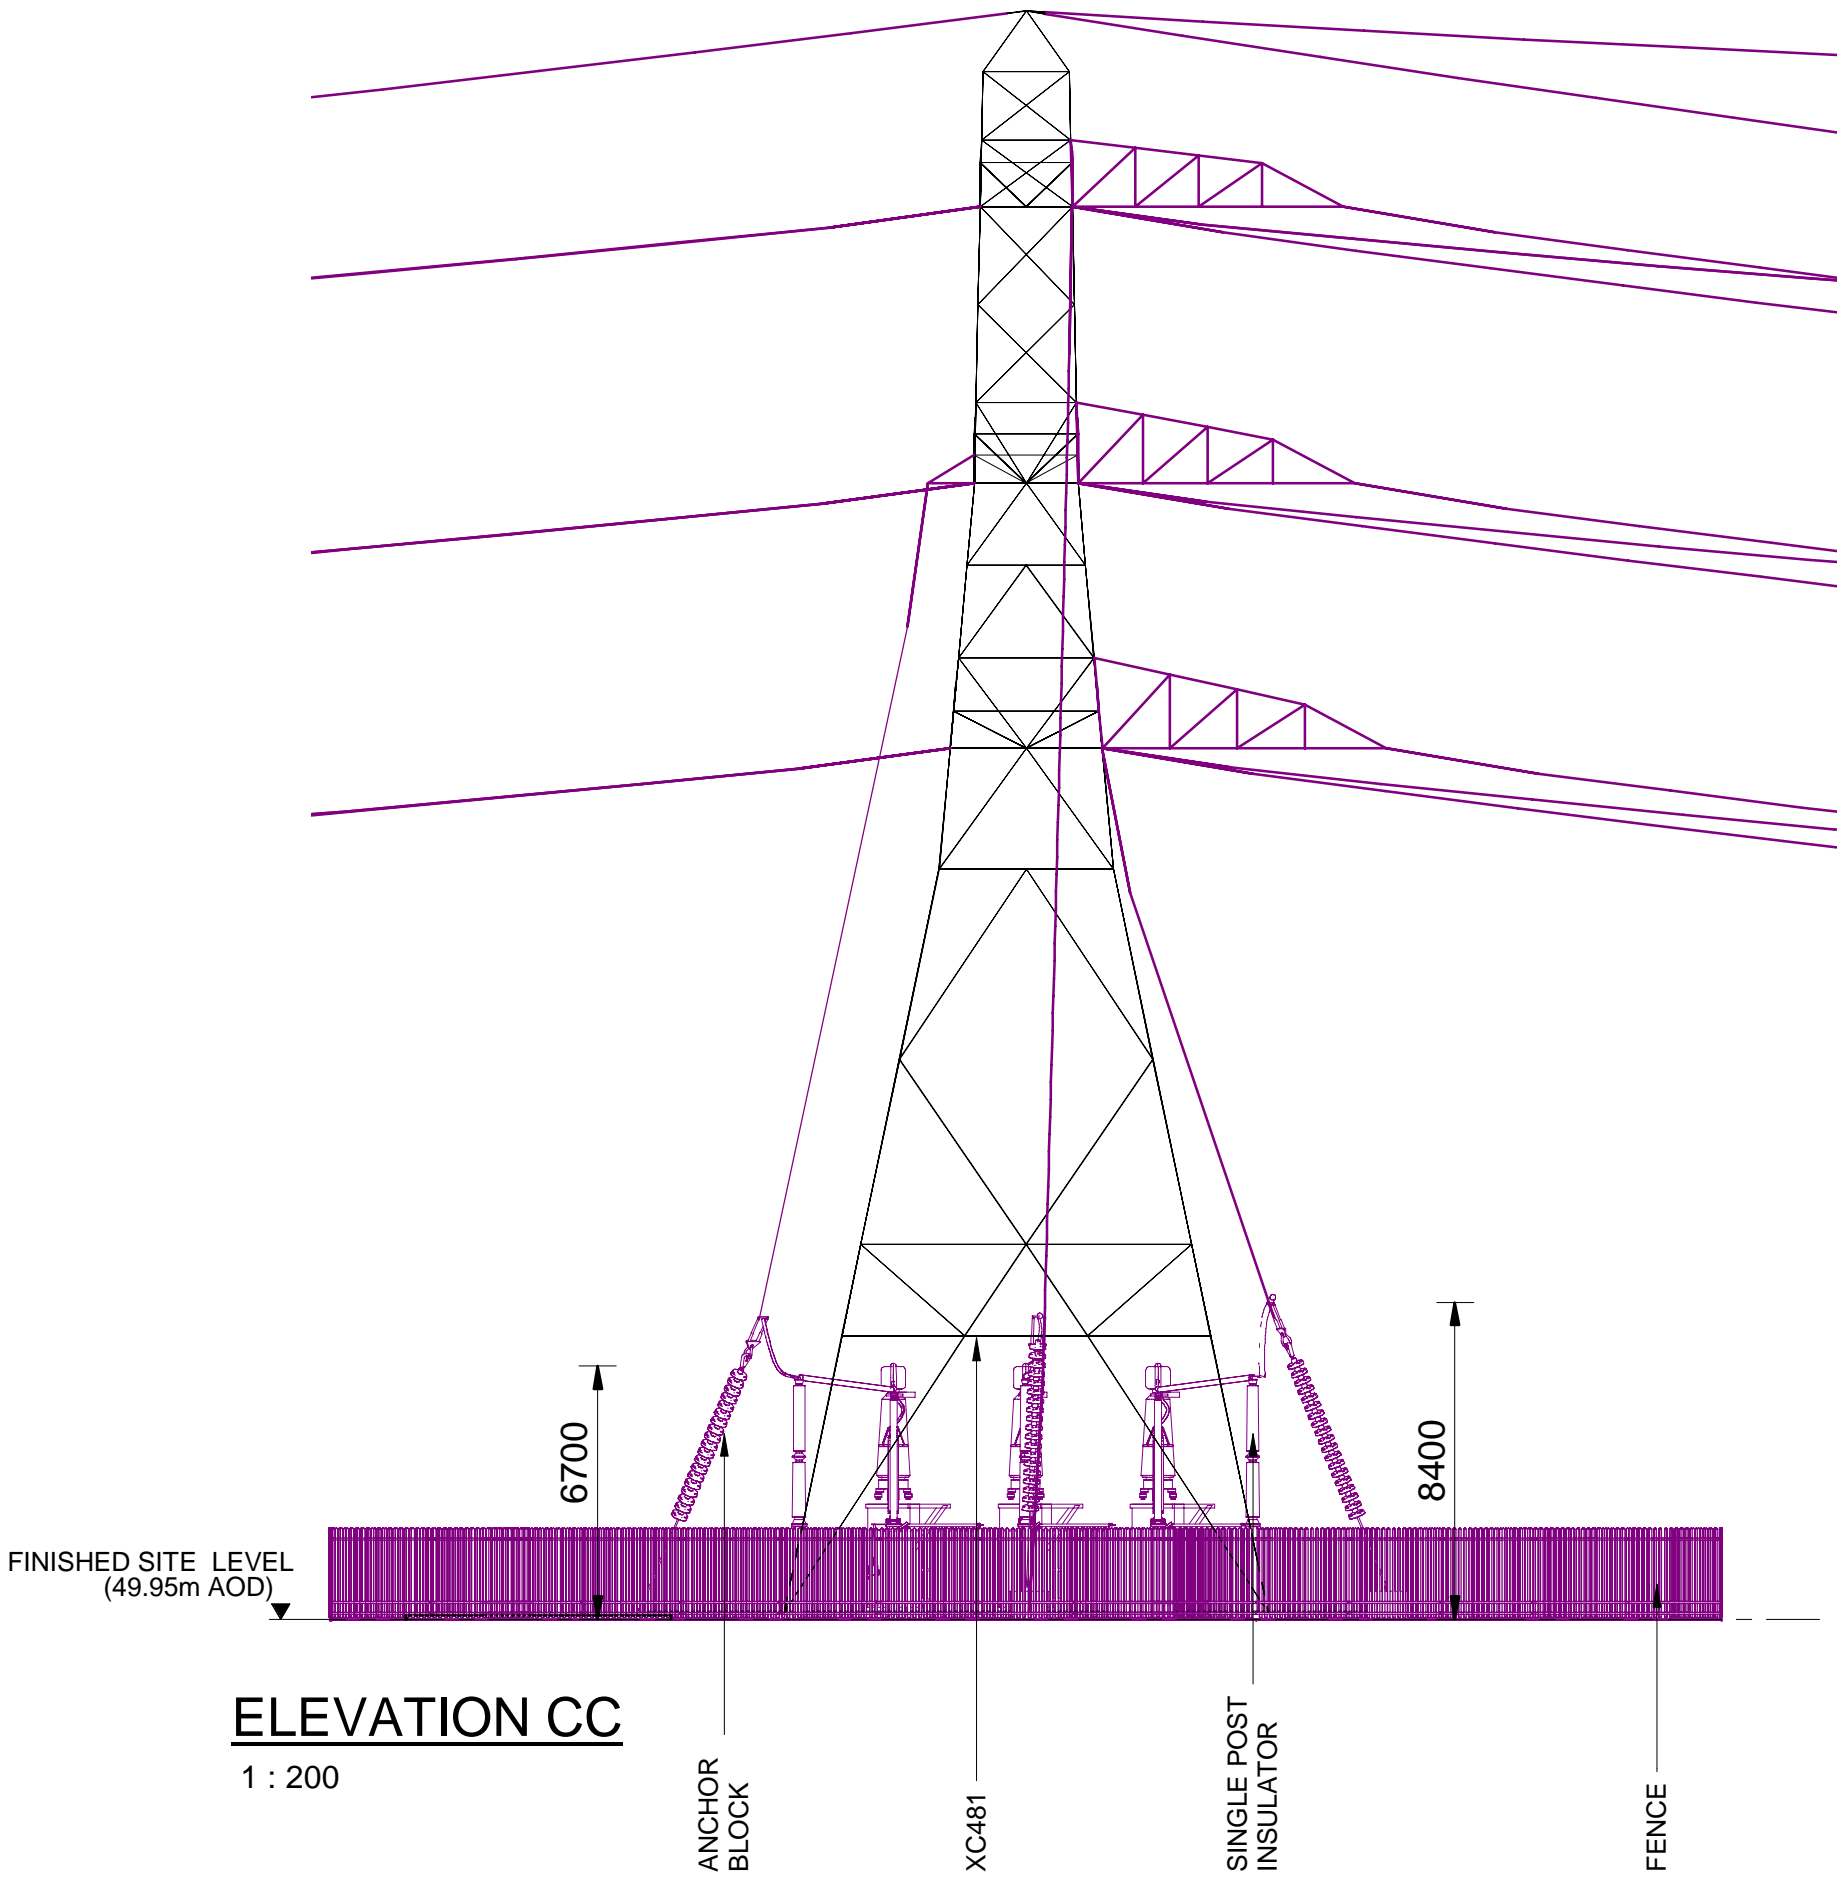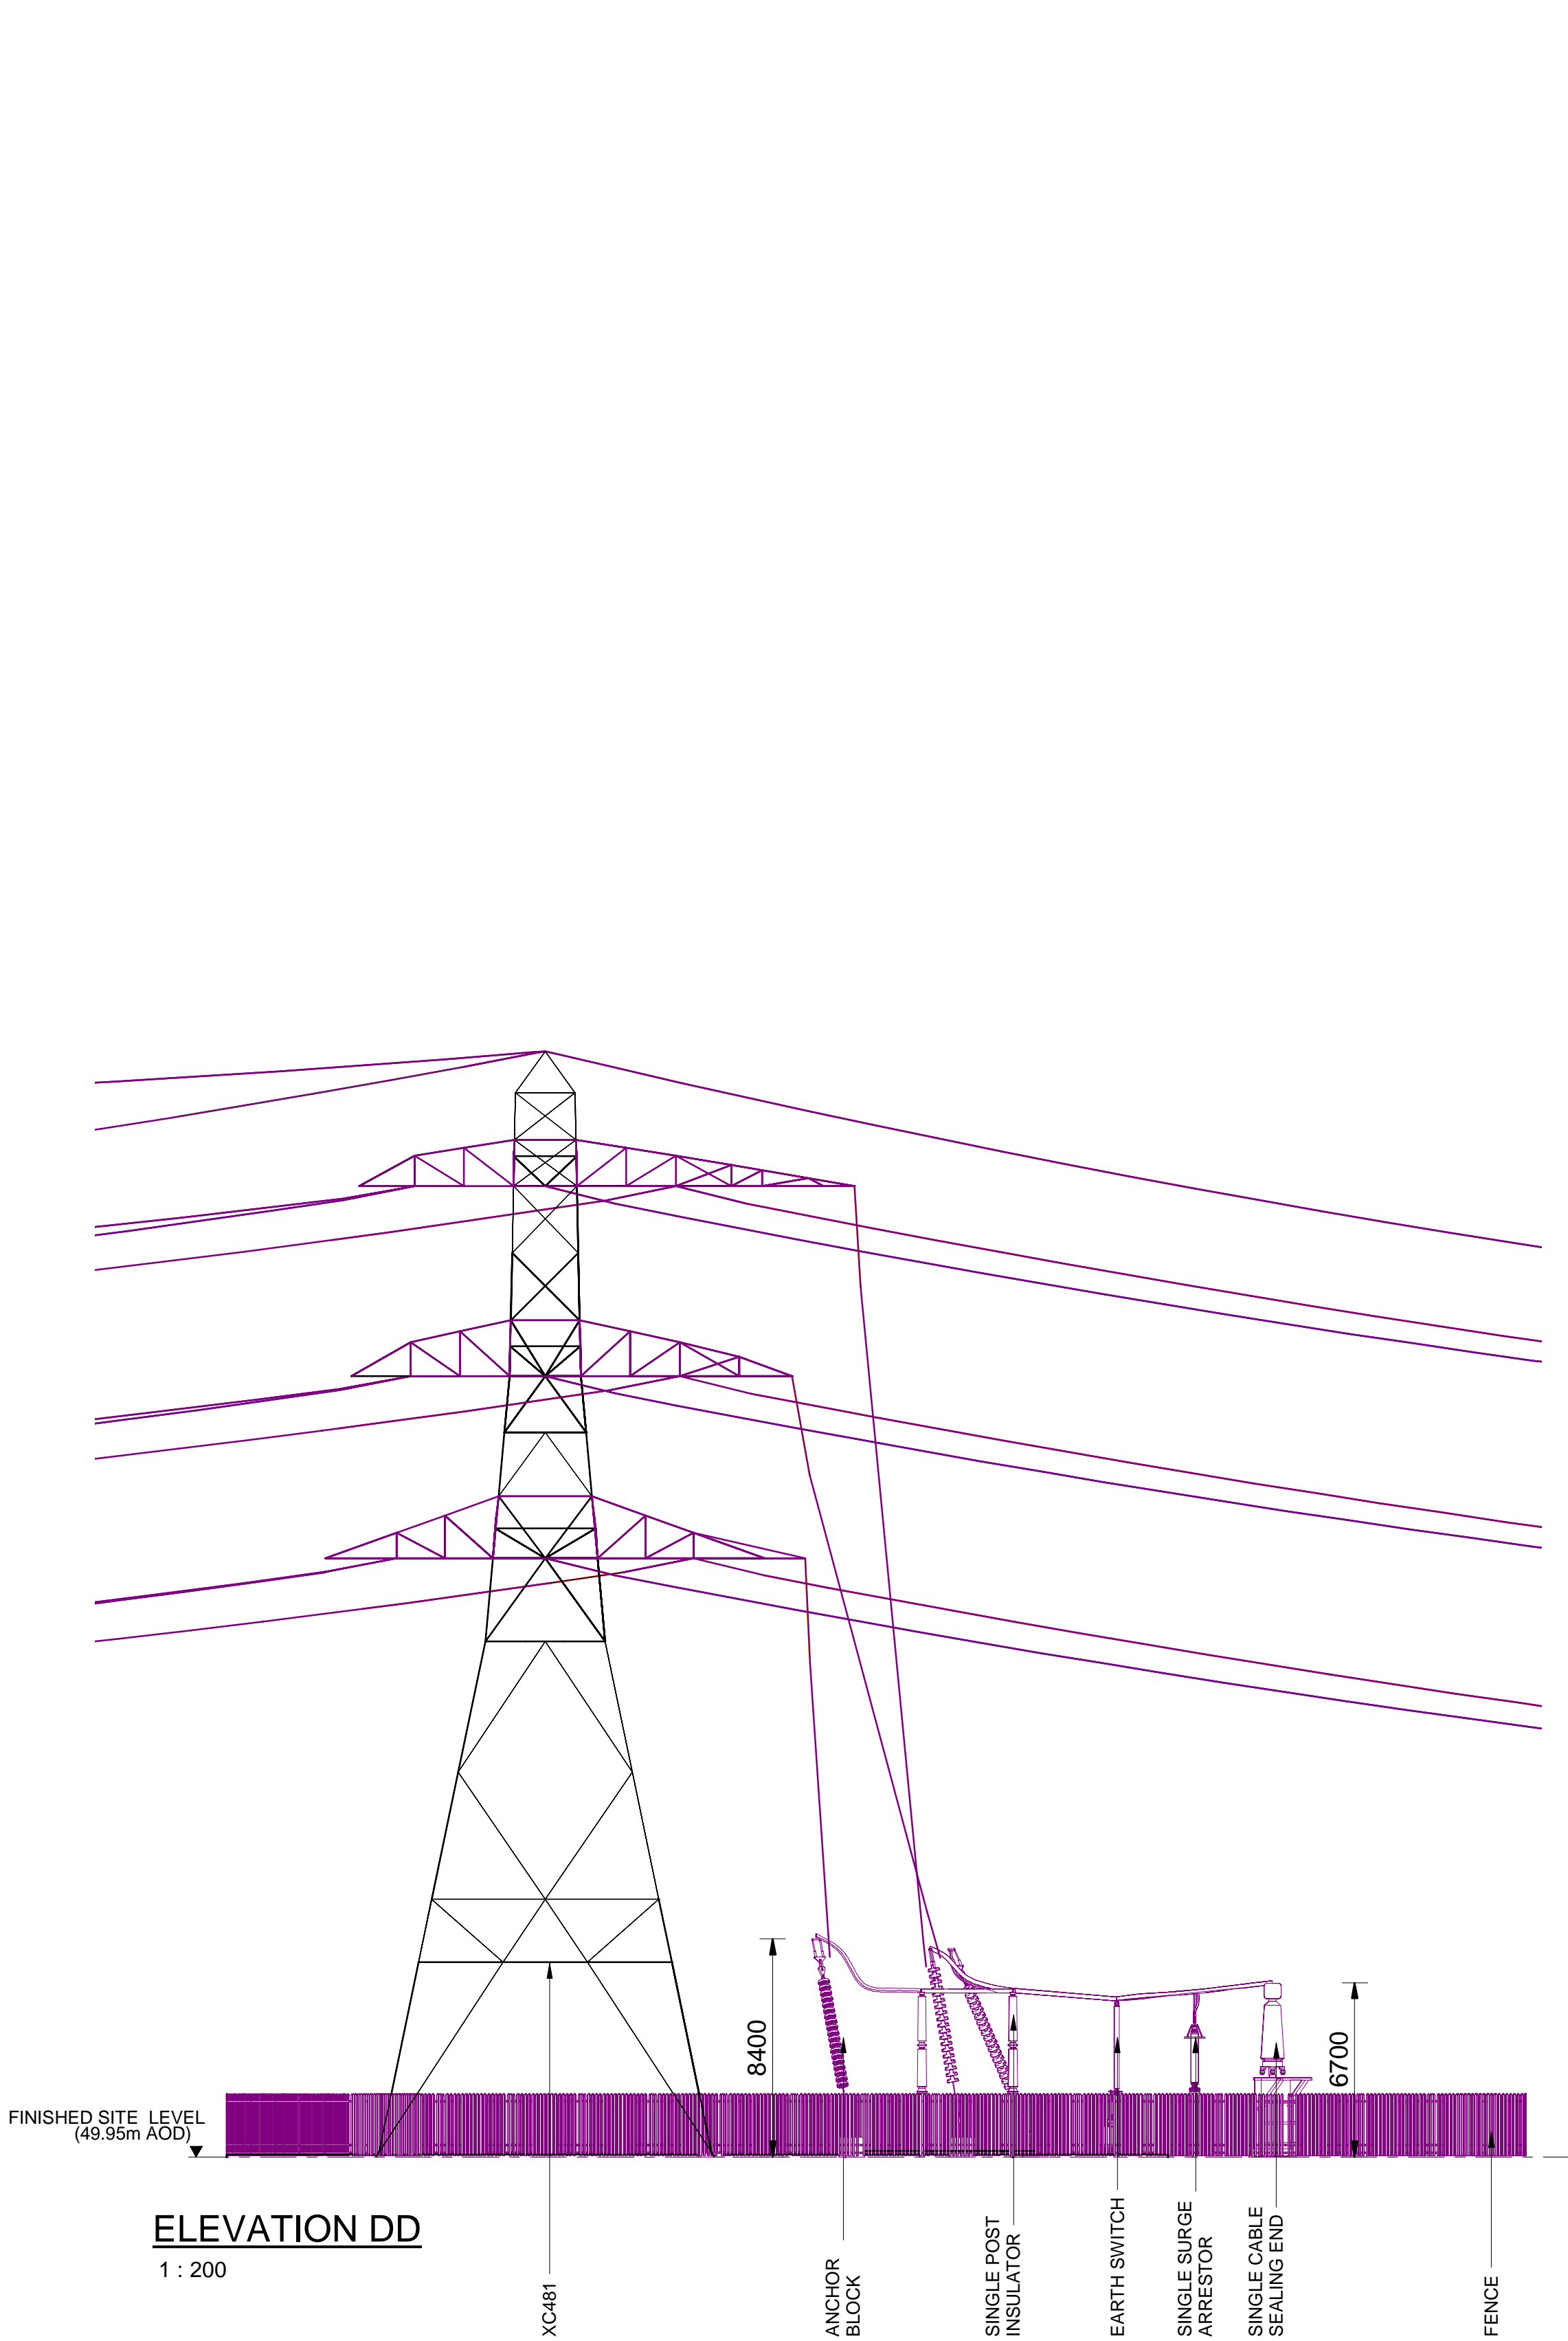NATIONAL GRID
(YORKSHIRE GREEN ENERGY
ENABLEMENT PROJECT) ORDER
DESIGN DRAWING: INDICATIVE CABLE SEALING END COMPOUND
ELEVATION - TADCASTER EAST 275kV CABLE SEALING END COMPOUND
REGULATION 5(2)(o)
SHEET 3 OF 3

nationalgrid

<u>Application Number</u>		EN020024	
<u>National Grid Drawing Reference</u>			
DCO_DE/PS/20_03			
Scale	Sheet Size	Sheet	Issue
1 : 200	A1	SHEET 3 OF 3	B

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NATIONAL GRID (YORKSHIRE GREEN ENERGY ENABLEMENT PROJECT) ORDER
DESIGN DRAWING: INDICATIVE EARTHWORKS LAYOUT - OVERTON
REGULATION 5(2)(o)
SHEET 1 OF 1

Legend

- ORDER LIMITS
- PERMANENT ACCESS ROAD
- SUBSTATION
- PERMANENT BELLMOUTH (AND LOCAL WIDENING OF HIGHWAY)
- PROPOSED DRAINAGE OUTFALL ACCESS ROAD
- PERMANENT EARTH BUND 1V:3H
- EARTHWORKS - CUT
- EARTHWORKS - FILL
- PROPOSED OHL

Notes

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- FOR ADDITIONAL DETAIL ON THE PLAN SUITES, PLEASE REFER TO DOCUMENT 2.3 PLAN GUIDANCE DOCUMENT, LOCATED IN VOLUME 2 OF THE DCO APPLICATION.
- NO UNAUTHORIZED DISCLOSURE, STORAGE OR COPYING.
- ALL SPATIAL COORDINATES RELATE TO THE ORDNANCE SURVEY, BRITISH NATIONAL GRID (OSGB36).

Reference drawings

- DESIGN DRAWING: INDICATIVE EARTHWORKS LONG SECTIONS - OVERTON DCO_DE/PS21_02

Coordinate System: British National Grid
Sheet X Centroid Coordinate: 455754
Sheet Y Centroid Coordinate: 457492

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Issue	Date	Remarks	Drawn	Checked	Approved

NATIONAL GRID
(YORKSHIRE GREEN ENERGY
ENABLEMENT PROJECT) ORDER
DESIGN DRAWING: INDICATIVE EARTHWORKS
LAYOUT - OVERTON
REGULATION 5(2)(o)
SHEET 1 OF 1

nationalgrid

Application Number
EN020024

National Grid Drawing Reference
DCO_DE/PS21_01


Scale	Sheet Size	Sheet	Issue
1:1500	A1	SHEET 1 OF 1	A

NATIONAL GRID (YORKSHIRE GREEN ENERGY ENABLEMENT PROJECT) ORDER
DESIGN DRAWING: INDICATIVE EARTHWORKS LONG SECTIONS - OVERTON
REGULATION 5(2)(o)
SHEET 2 OF 2

Legend

- EXISTING GROUND LEVEL
- FORMATION LEVEL
- SUBBASE LEVEL
- TOPSOIL STRIP


SECTION A - LONG SECTION
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Notes
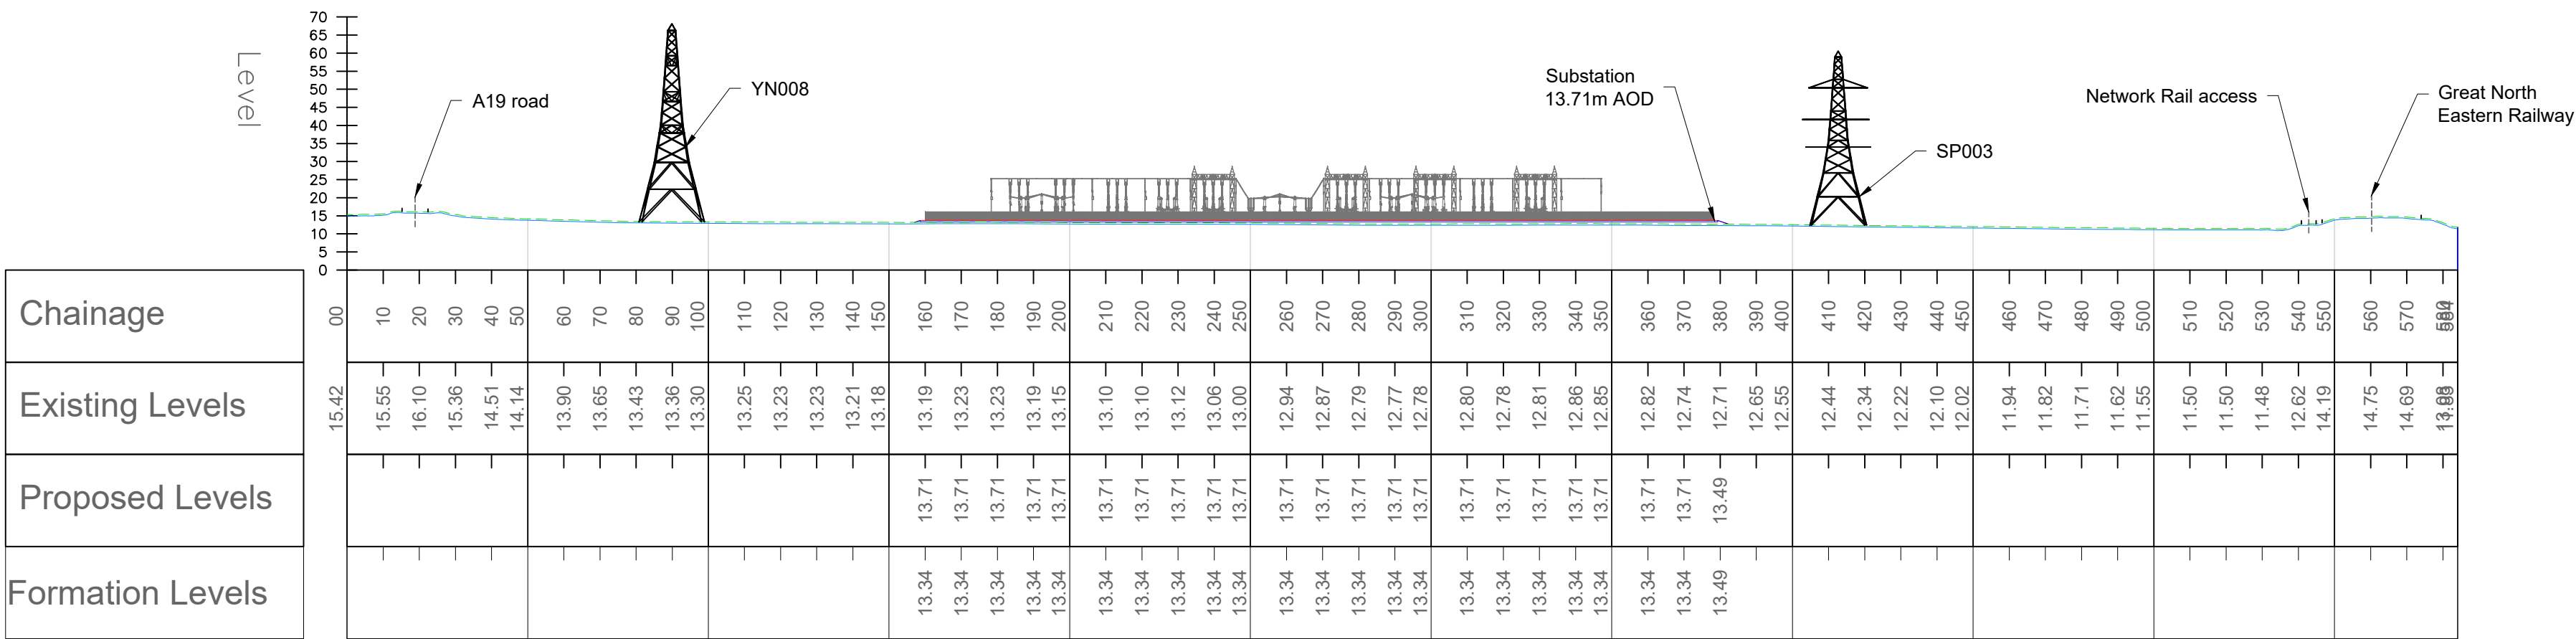
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SECTION B - LONG SECTION
SCALE: H 1:1500,V 1:1500. DATUM: 0.000



Reference drawings

- DESIGN DRAWING: INDICATIVE EARTHWORKS LAYOUT - OVERTON DCO_DE/PS21_01
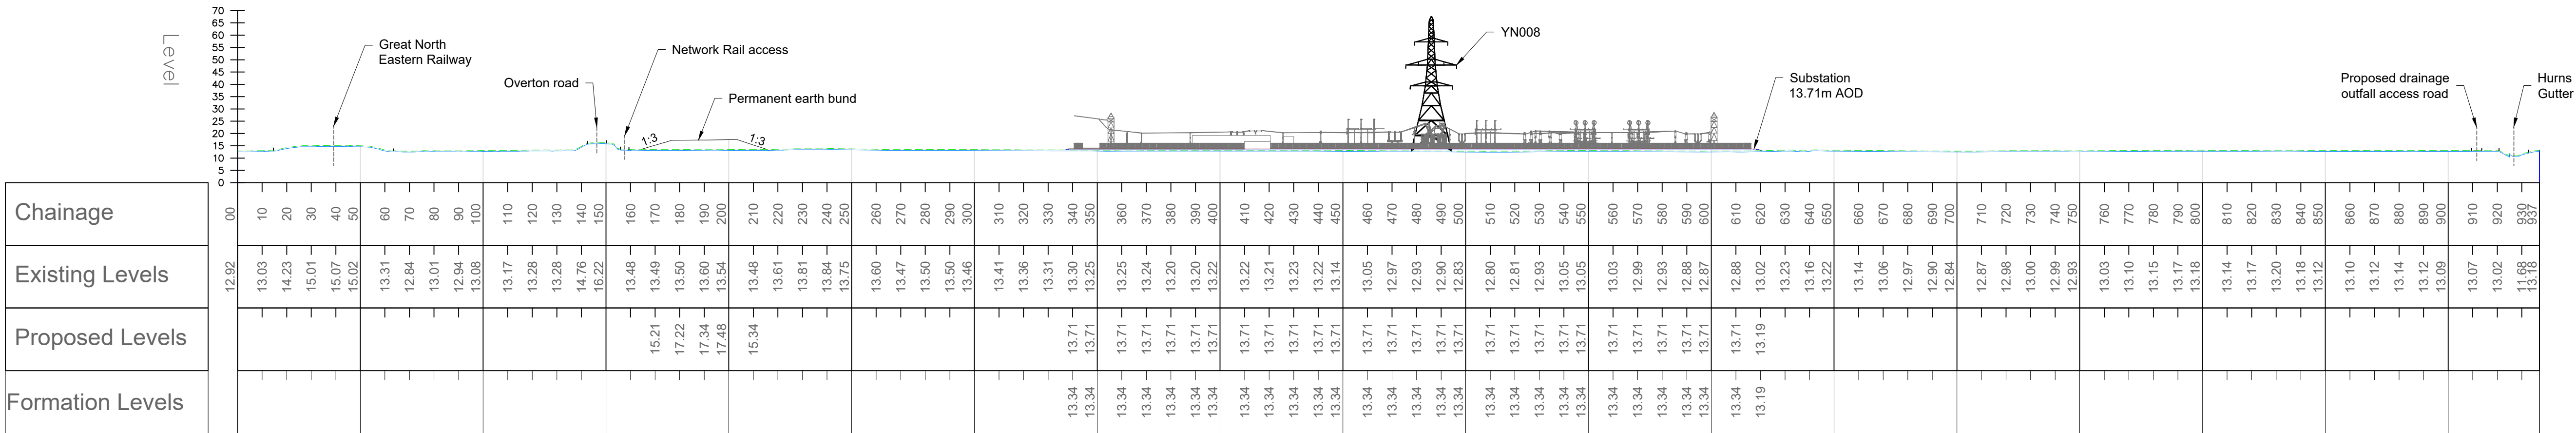
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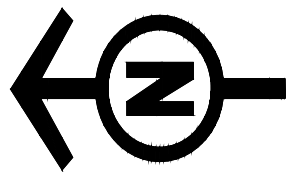
A	26/04/23	FOR DCO SUBMISSION	PS	SF	EMD
Issue	Date	Remarks	Drawn	Checked	Approved

Title
NATIONAL GRID
(YORKSHIRE GREEN ENERGY
ENABLEMENT PROJECT) ORDER
DESIGN DRAWING: INDICATIVE EARTHWORKS
LONG SECTIONS - OVERTON
REGULATION 5(2)(o)
SHEET 2 OF 2

nationalgrid

Application Number		EN020024	
National Grid Drawing Reference			
DCO_DE/PS/21_02			
Scale	Sheet Size	Sheet	Issue
AS SHOWN	A1	SHEET 2 OF 2	A

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NATIONAL GRID (YORKSHIRE GREEN ENERGY ENABLEMENT PROJECT) ORDER
DESIGN DRAWING: INDICATIVE EARTHWORKS LAYOUT - MONK FRYSTON
REGULATION 5(2)(o)
SHEET 1 OF 1

Legend

- ORDER LIMITS
- SUBSTATION
- PERMANENT EARTH BUND 1V:3H
- EARTHWORKS - CUT
- EARTHWORKS - FILL
- PROPOSED OHL
- UTILITIES (BASED ON C2 RECORDS)
- NATIONAL GRID OVERHEAD LINE
- 33kV OVERHEAD LINE

Notes

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Reference drawings

- DESIGN DRAWING: INDICATIVE EARTHWORKS LONG SECTIONS - MONK FRYSTON DCO_DE/PS22_02

Coordinate System: British National Grid
Sheet X Centroid Coordinate: 455675
Sheet Y Centroid Coordinate: 457427

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Issue					
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Issue	Date	Remarks	Drawn	Checked	Approved

Title


NATIONAL GRID
(YORKSHIRE GREEN ENERGY
ENABLEMENT PROJECT) ORDER
DESIGN DRAWING: INDICATIVE EARTHWORKS
LAYOUT - MONK FRYSTON
REGULATION 5(2)(o)
SHEET 1 OF 1

nationalgrid

Application Number
EN020024

National Grid Drawing Reference
DCO_DE/PS/22_01

Scale	Sheet Size	Sheet	Issue
1:1500	A1	SHEET 1 OF 1	A

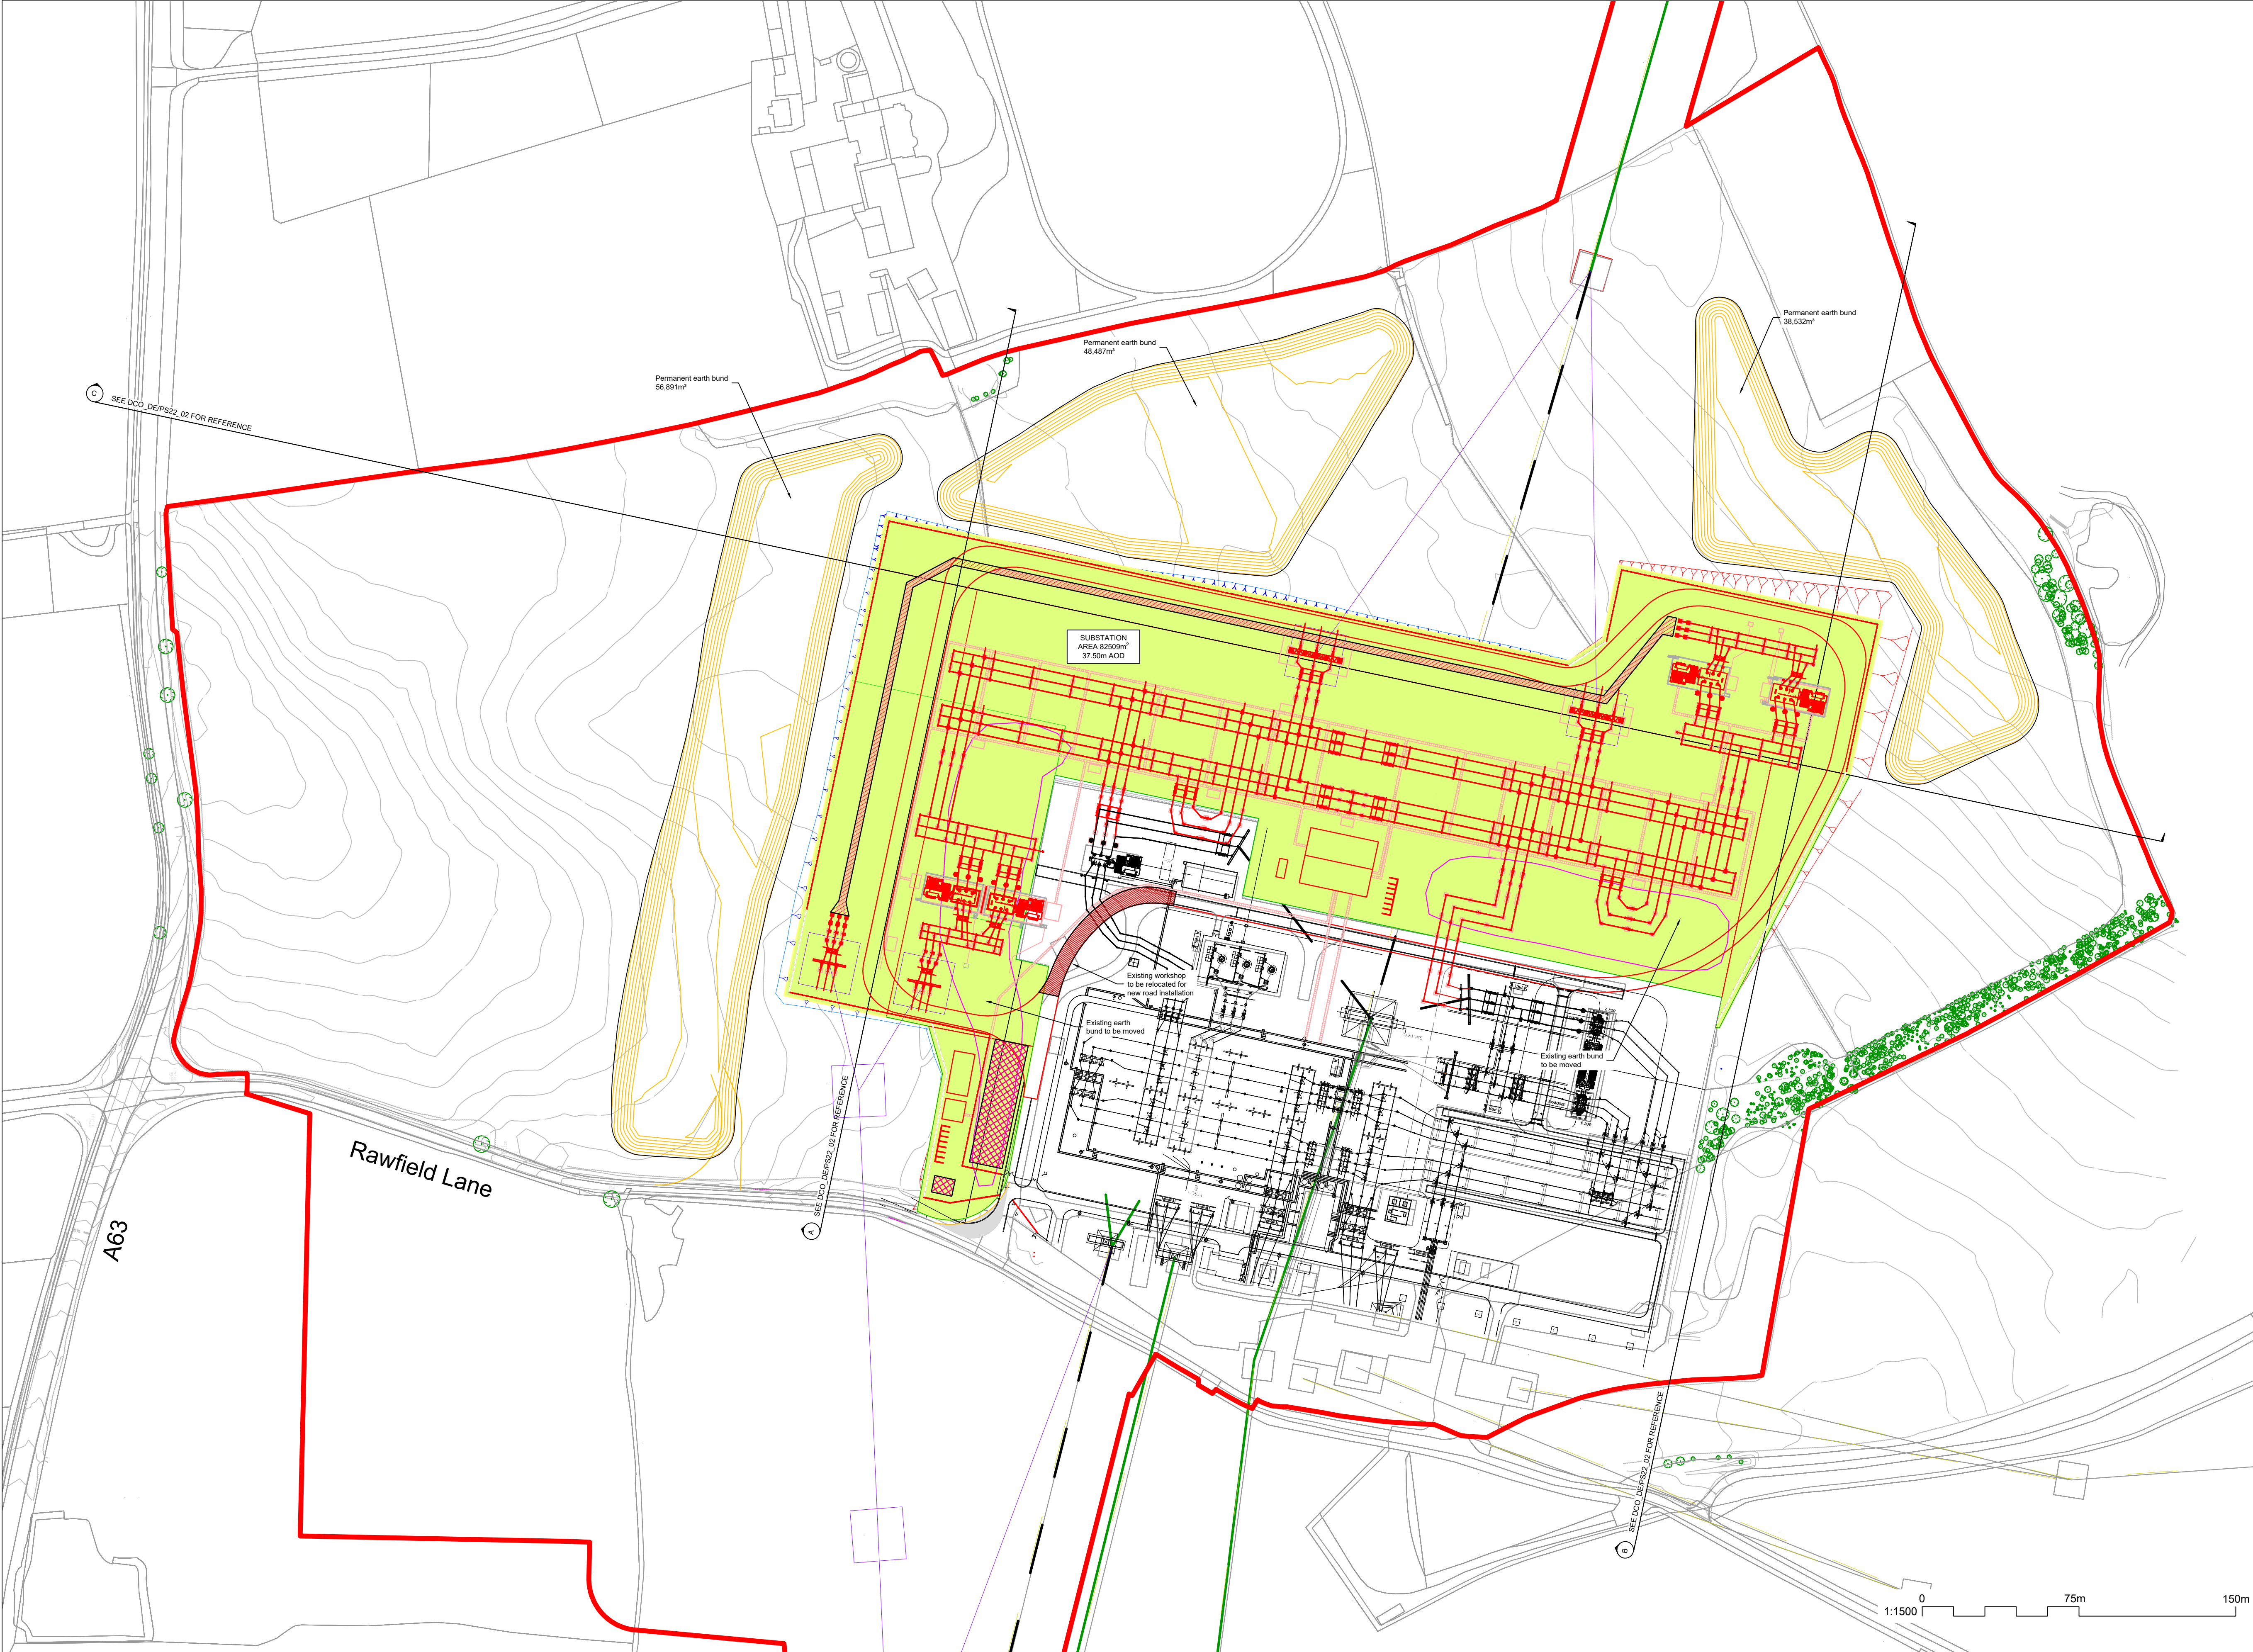


NATIONAL GRID (YORKSHIRE GREEN ENERGY ENABLEMENT PROJECT) ORDER
DESIGN DRAWING: INDICATIVE EARTHWORKS LONG SECTIONS - MONK FRYSTON
REGULATION 5(2)(o)
SHEET 2 OF 2


Legend

- EXISTING GROUND PROFILE
--- PROPOSED FORMATION PROFILE
--- PROPOSED TOPSOIL STRIP PROFILE
--- PROPOSED FINISHED LEVEL PROFILE



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SECTION B - LONG SECTION
SCALE: H 1:1500,V 1:1500. DATUM: 15.000

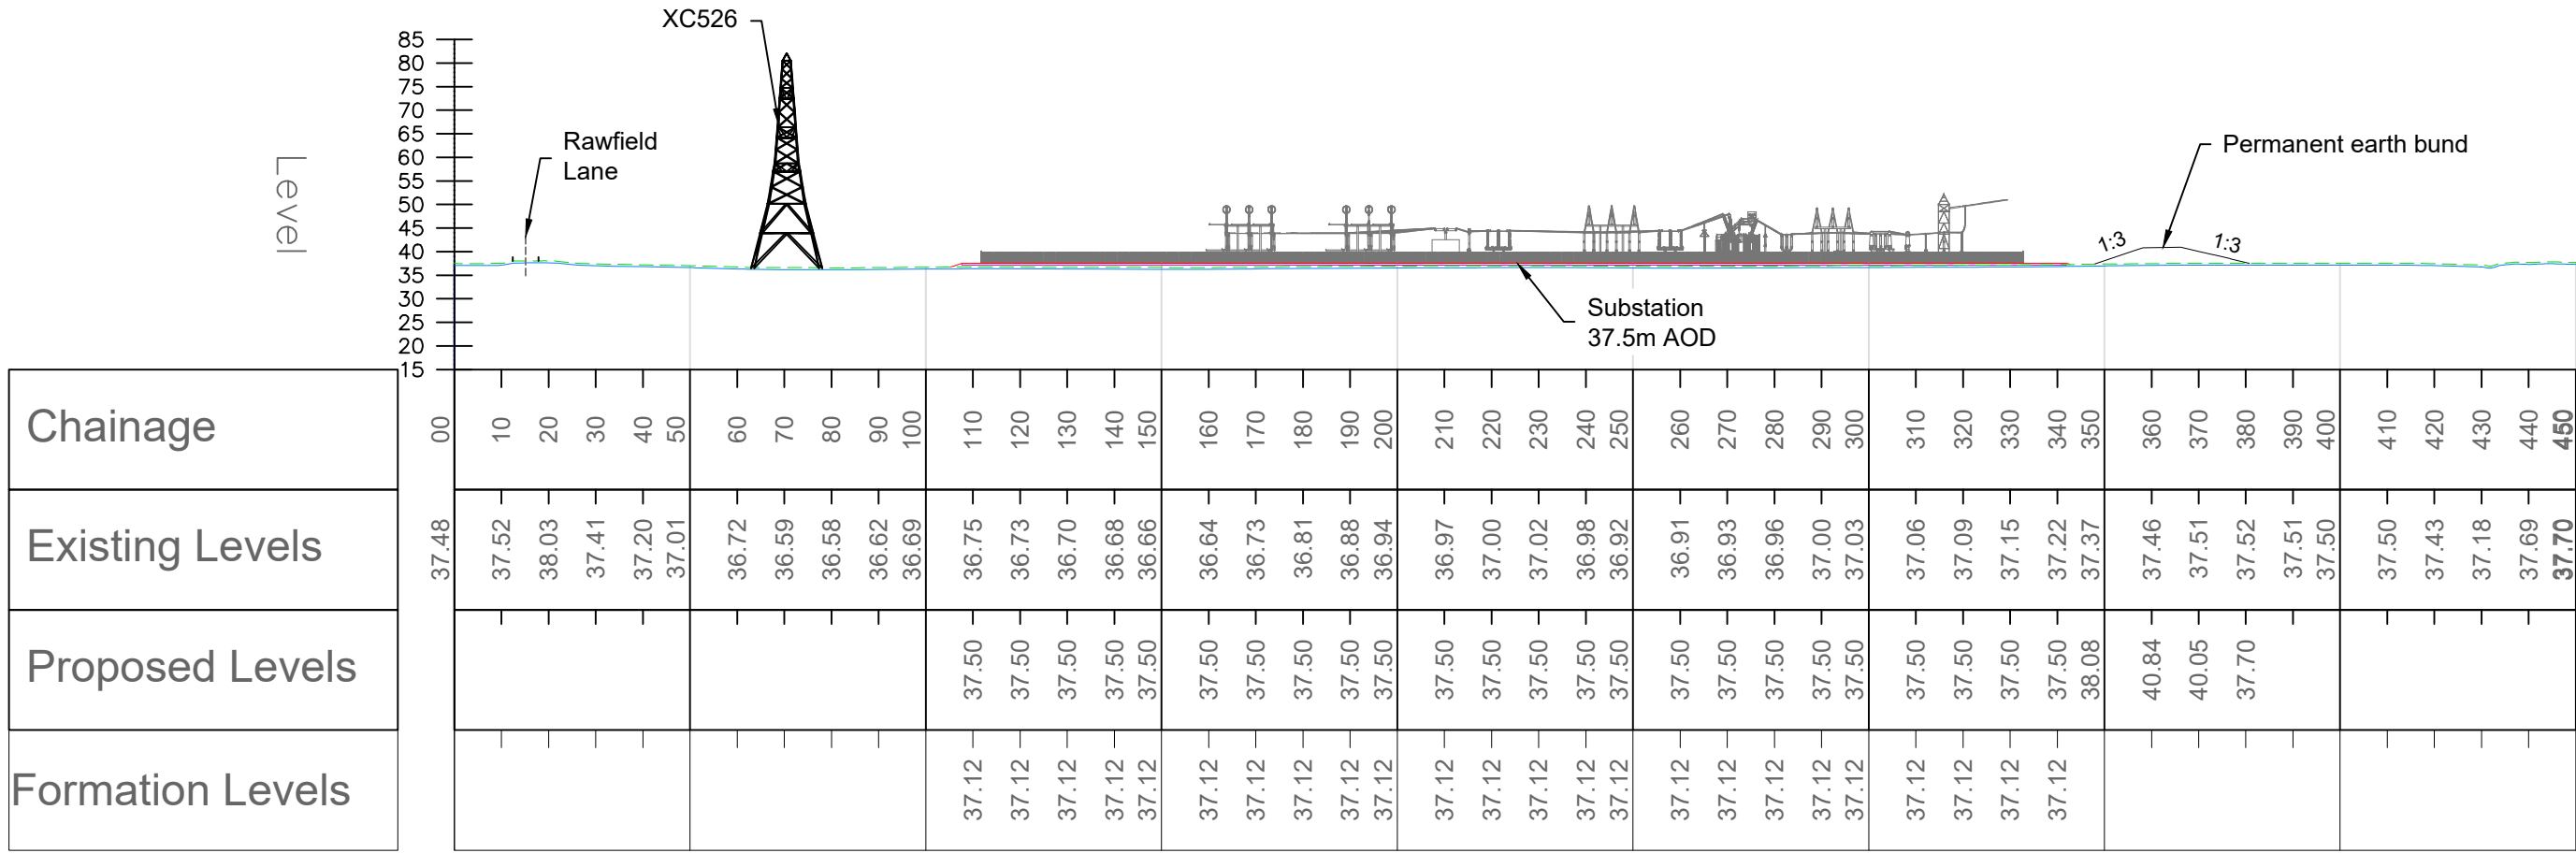

SECTION C - LONG SECTION
SCALE: H 1:1500,V 1:1500. DATUM: 15.000

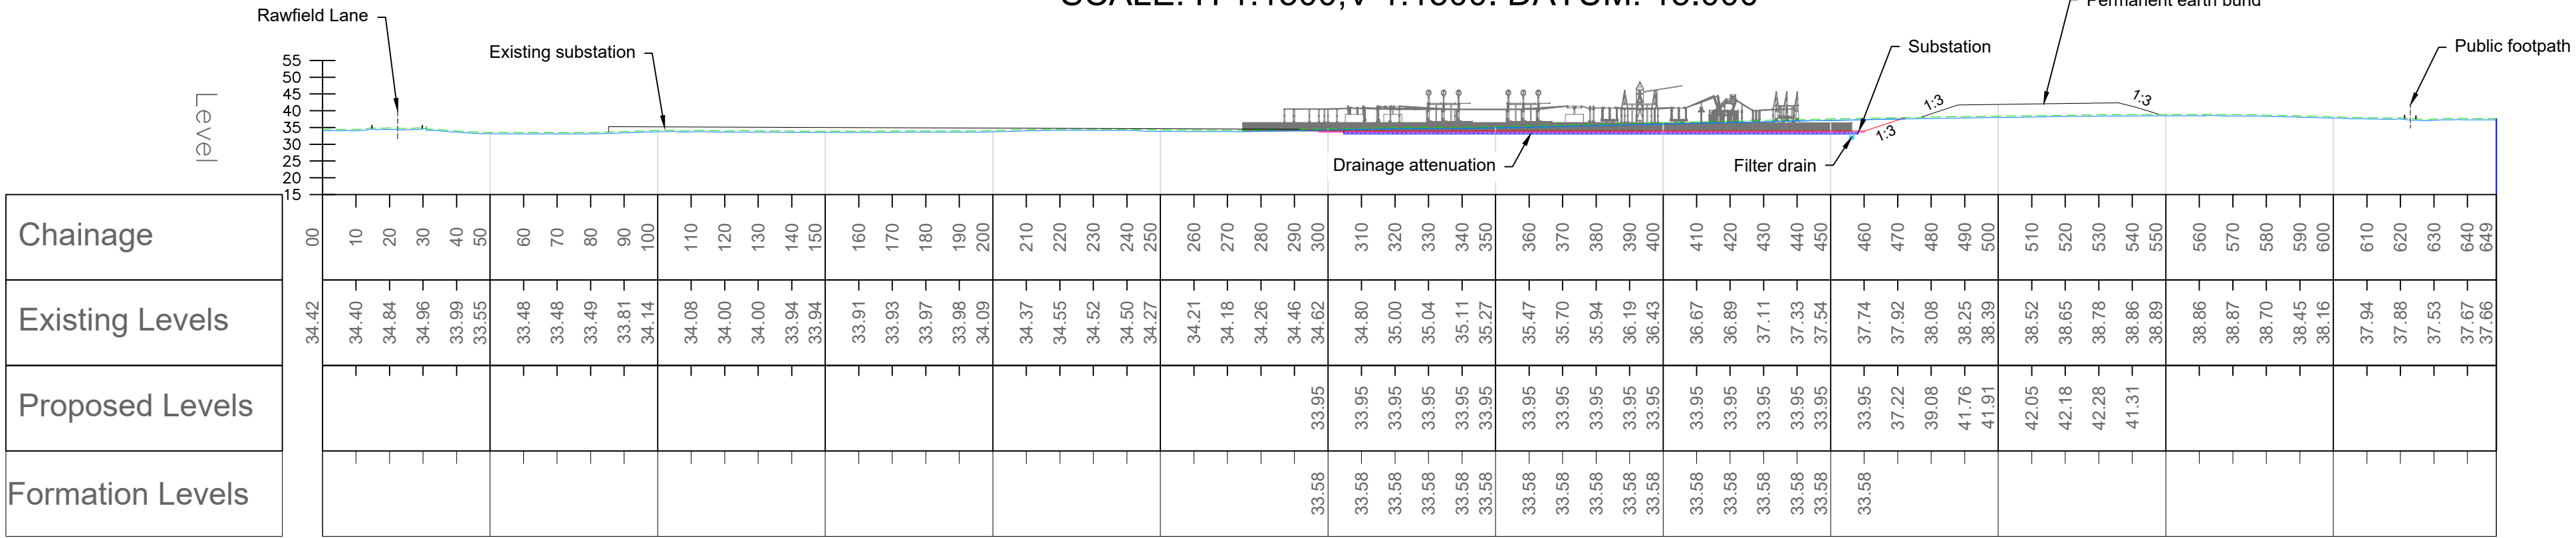

Notes
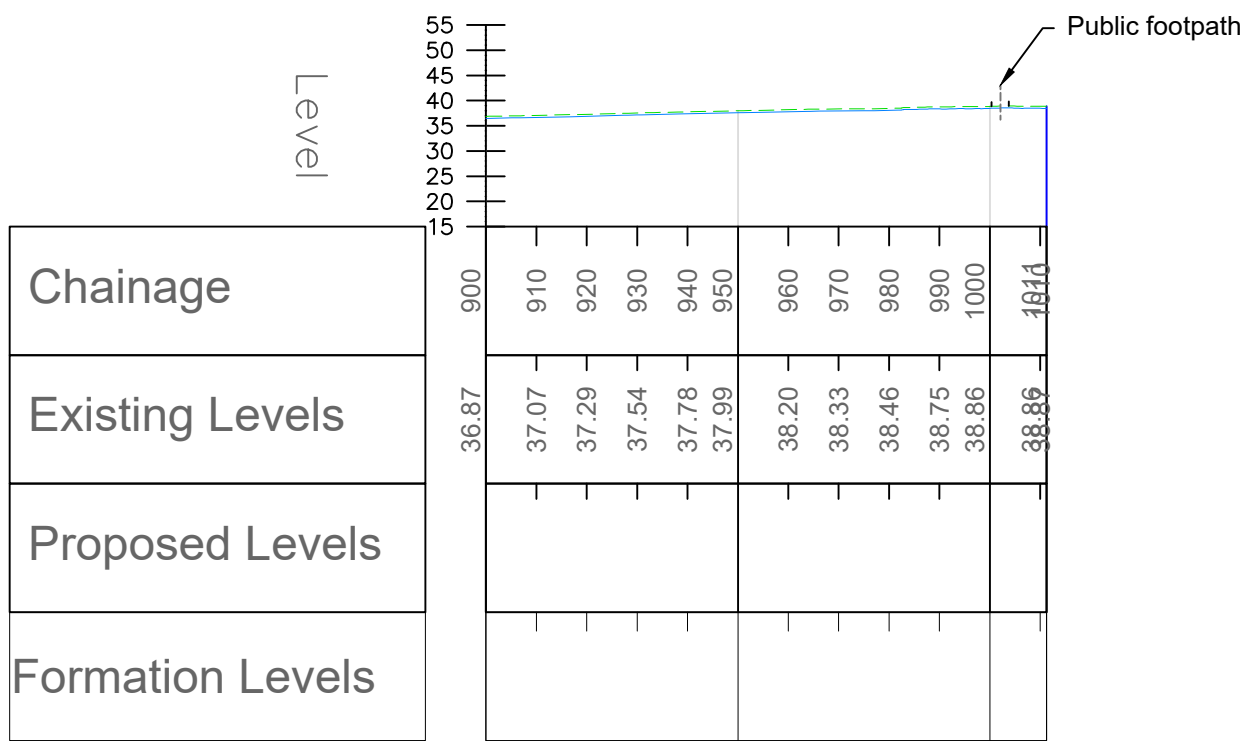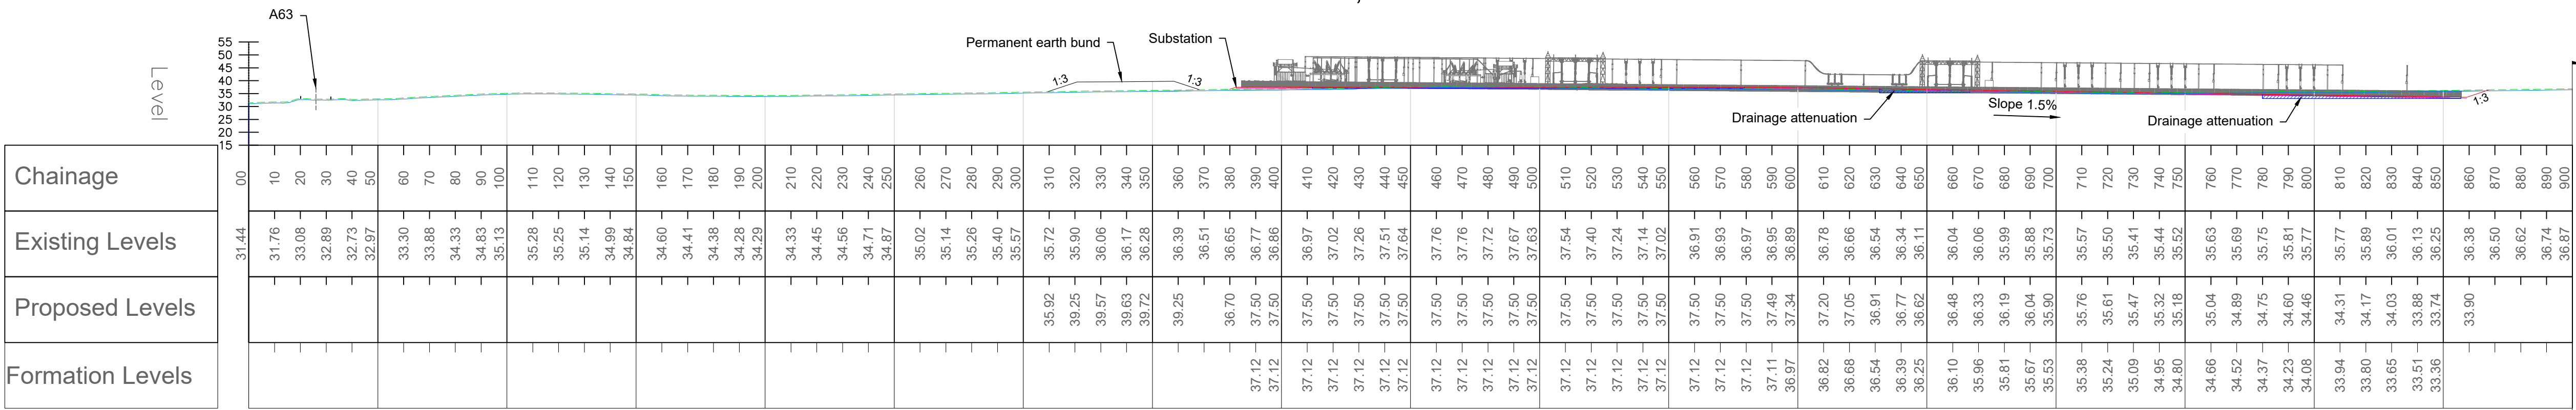
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Reference drawings

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NATIONAL GRID
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DESIGN DRAWING: INDICATIVE EARTHWORKS
LONG SECTIONS - MONK FRYSTON
REGULATION 5(2)(o)
SHEET 2 OF 2

nationalgrid

Application Number
EN020024

National Grid Drawing Reference
DCO_DEIPS22_02

Scale	Sheet Size	Sheet	Issue
AS SHOWN	A1	SHEET 2 OF 2	A